

### TREE MANAGEMENT NOTES - GENERAL


- 1. THE PREPARATION OF THE TREE PRESERVATION PLAN HAS BEEN COORDINATED WITH THE PREPARATION OF THE GRADING CONTROL PLAN AND EROSION & SEDIMENT CONTROL PLAN. THE PLANS HAVE BEEN REVIEWED BY THE LANDSCAPE ARCHITECT AND ENGINEERING CONSULTANTS. THE RELEVANT FEATURES OF THESE PLANS ARE IN CONFORMITY WITH EACH OTHER.
- 2. NO SERVICING, GRADING OR OTHER CONSTRUCTION ACTIVITY IS TO BEGIN UNTIL THE INSTALLATION OF THE TREE PROTECTION FENCING AND ANY OTHER PROTECTION MEASURES HAVE BEEN CERTIFIED BY THE LANDSCAPE ARCHITECT. PROTECTION FENCING SHALL NOT BE ALTERED OR RELOCATED UNLESS AUTHORIZED IN WRITING BY THE LANDSCAPE ARCHITECT.
- 3. IT IS THE RESPONSIBILITY OF THE CONTRACTOR TO ENSURE THAT THEY ARE AWARE OF ALL MEASURES BEING TAKEN TO PROTECT ALL TREES IDENTIFIED.
- 4. ALL DAMAGE TO TREES WILL BE REPORTED TO THE CONSULTANT IMMEDIATELY BY THE CONTRACTOR'S FOREPERSON.
- 5. FOR SILT FENCING DETAILS REFER TO EROSION AND SEDIMENT CONTROL PLAN BY LANHACK CONSULTANTS INC. / S. LLEWELLYN & ASSOCIATES LTD.
- 6. FOR SERVICING AND GRADING INFORMATION, REFER TO DRAWINGS BY LANHACK CONSULTANTS INC. / S. LLEWELLYN & ASSOCIATES LTD.

### Tree Inventory-Table 1 (Updated from inventory completed on January 26th, 2017)

Site Date: Dec.11, 2017

Field Personel: GSP Group- Richard Turner, Justin Whalen

Tree #	Botanical Name	Common Name	Stems	DBH	Crown Dia.	Condition	Comments	Environment	Recommendations
1	Acer negundo	Manitoba Maple	1	300	4	Fair	Irregular canopy	Co-Dominant	Remove (Construction)
2	Fraxinus americana	Ash	1	400	8	Poor	Emerald Ash Borer	Co-Dominant	Remove (Construction)
3	Acer saccharinum	Silver Maple	1	400	12	Fair	Irregular canopy	Co-Dominant	Remove (Construction)
4	Acer saccharinum	Silver Maple	1	350	10	Fair	Uniform Specimen	Dominant	Remove (Construction)
5	Fraxinus americana	Ash	1	300	10	Poor	Emerald Ash Borer	Dominant	Remove (Construction)
6	Acer saccharinum	Silver Maple	1	400	10	Good	Irregular canopy	Co-Dominant	Remove (Construction)
7	Acer saccharum	Sugar Maple	1	350	10	Good	Uniform Specimen	Co-Dominant	Remove (Construction)

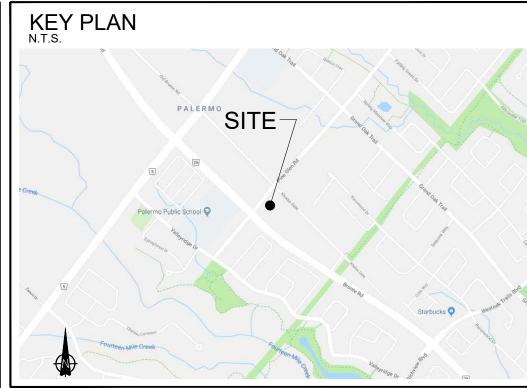

## Legend

EXISTING TREE TO BE REMOVED

EXISTING TREE TO REMAIN

TREE TAG NUMBER — - - PROJECT BOUNDARY

#### **GENERAL NOTES:**

1. DRAWINGS NOT TO BE USED FOR CONSTRUCTION UNLESS AUTHORIZED BY THE LANDSCAPE ARCHITECT

DO NOT CONSTRUCT ENGINEERING WORKS FROM THESE DRAWINGS.

- 2. CONTRACTOR SHALL REPORT ANY DISCREPANCIES BETWEEN THE DRAWINGS AND SITE CONDITIONS PRIOR TO COMMENCEMENT OF THE WORK
- 3. ALL UTILITY LOCATES ARE THE RESPONSIBILITY OF THE CONTRACTOR. HAND DIG WITHIN THE LIMITS RECOMMENDED BY THE SERVICE UTILITY. UTILITY CONFLICTS WITH PROPOSED TREE LOCATIONS MUST BE REPORTED IMMEDIATELY TO THE LANDSCAPE ARCHITECT
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- SERVICING INFORMATION REFER TO DRAWINGS BY S. LLEWLLYN & ASSOCIATES LTD. 6. LANDSCAPE DRAWINGS SHOW ENGINEERING INFORMATION FOR DESIGN PURPOSES ONLY.

# VEGETATION MANAGEMENT PLAN 2418 KHALSA GATE

OAKVILLE, ON.

ISSUED FOR SITE PLAN APPROVAL, NOT FOR CONSTRUCTION.





Jan 30, 2018 Issued for Review Feb 23, 2018 Issued for Review Mar 21, 2018 Issued for SPA


REVISIONS



Project No.: 17251

www.gspgroup.ca Date: March 14, 2018 Drawn By: JW

Scale: 1:200

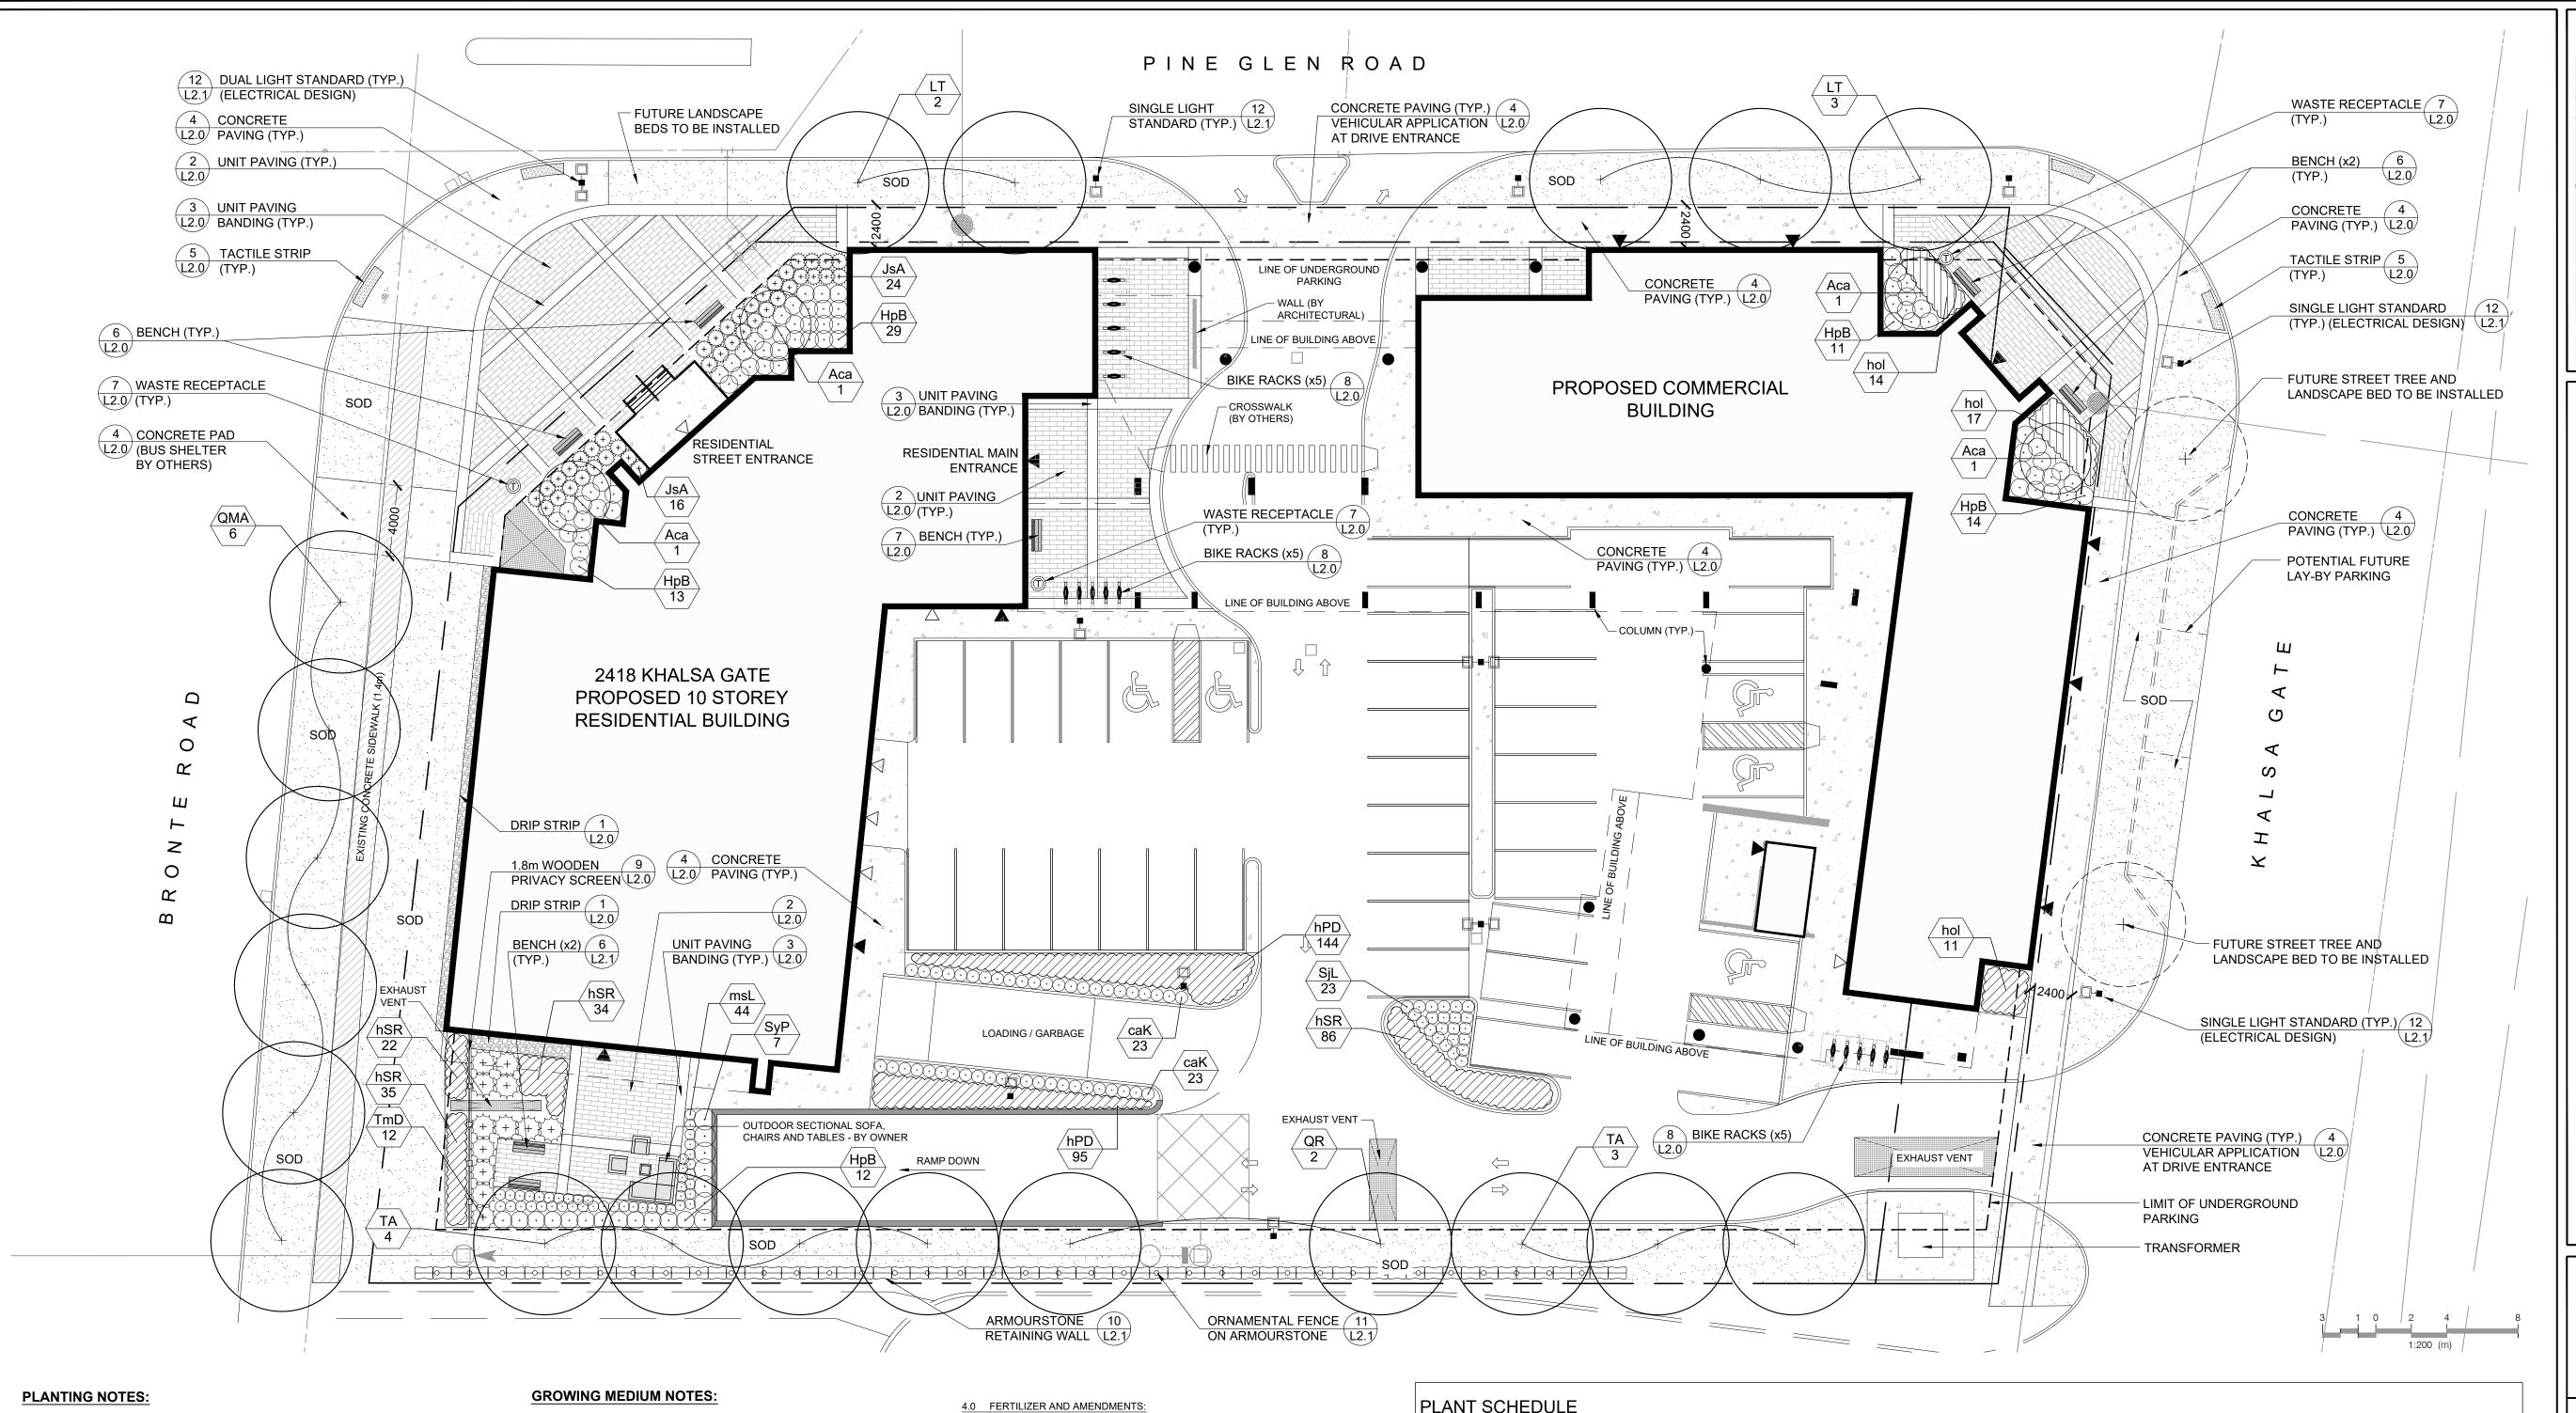

- 1. ALL PLANT MATERIAL SHALL BE NO.1 NURSERY GROWN, MEETING SPECIFICATIONS FOR SIZE, HEIGHT, SPREAD, GRADING, QUALITY, METHOD OF CULTIVATION, AND BALLING AND BURLAP SPECIFICATIONS AS SET OUT IN THE LATEST EDITION OF THE GUIDE SPECIFICATION FOR NURSERY STOCK PREPARED BY THE CNLA.
- 2. NO SUBSTITUTIONS IN SPECIES, CULTIVAR, QUANTITY, SIZE OR CONDITION WILL BE PERMITTED WITHOUT THE WRITTEN APPROVAL OF THE CONSULTANT. ANY UNAPPROVED SUBSTITUTED MATERIAL WILL BE REQUIRED TO BE REMOVED FROM THE SITE AT THE EXPENSE OF THE CONTRACTOR.
- 3. ANY INCONSISTENCIES FOUND IN THE QUANTITIES AS SHOWN ON THE PLAN AND THE PLANT LIST SHALL BE IMMEDIATELY REPORTED TO THE CONSULTANT.
- 4. LAYOUT SHALL BE THE RESPONSIBILITY OF THE CONTRACTOR. LAYOUT, PLANT
- PRIOR TO INSTALLATION. 5. NATIVE OR IMPORTED TOPSOIL SHALL BE TESTED AS SPECIFIED AND APPROVED BY THE CONSULTANT PRIOR TO ADDING ANY AMENDMENTS AND PLACEMENT. PLANTING MIX, WHERE

INDICATED, SHALL FOLLOW THE MIX SPECIFICATIONS.

STAKE-OUT AND DELIVERED PLANT MATERIAL SHALL BE APPROVED BY THE CONSULTANT

- 6. PROVIDE 450MM MINIMUM DEPTH OF APPROVED TOPSOIL OR PLANTING MIX IN ALL BEDS, UNLESS OTHERWISE NOTED. ALL BEDS SHALL BE MULCHED WITH APPROVED MULCH TO A MINIMUM DEPTH OF 100MM, UNLESS OTHERWISE NOTED. DEPTHS SHALL BE THOSE ACHIEVED UNDER LIGHT COMPACTION. AREAS TO BE SODDED OR SEEDED SHALL BE PROVIDED WITH 150 MM OF APPROVED TOPSOIL, COMPACTED TO 85% SPD.
- 7. NO BARE-ROOT PLANTING SHALL BE PERMITTED BETWEEN MAY 15 AND OCTOBER 15.
- 8. PLANT MATERIAL SHALL BE THOROUGHLY WATERED AT THE TIME OF PLANTING. 9. THOSE AREAS NOT SPECIFICALLY IDENTIFIED FOR PLANTING, OR OTHERWISE NOTED,
- SHALL BE SODDED. SODDING SHALL BE MAINTAINED AND WARRANTED UNTIL FIRST CUT. SEEDING SHALL BE MAINTAINED AND WARRANTIED UNTIL OCTOBER 1 FOR SPRING SEEDING AND JUNE 1 FOR FALL SEEDING.
- 10. ALL TREES AND SHRUBS SHALL BE UNDER WARRANTY FOR A PERIOD OF 24 MONTHS COMMENCING ON THE DATE OF ACCEPTANCE.
- 11. THE CONTRACTOR SHALL PROVIDE MAINTENANCE IMMEDIATELY AFTER THE PLANTS ARE INSTALLED AND CONTINUE THROUGHOUT THE ENTIRE WARRANTY PERIOD. MAINTENANCE REQUIREMENTS SHALL INCLUDE ALL PROCEDURES CONSISTENT WITH PROPER HORTICULTURAL PRACTICES TO ENSURE NORMAL, VIGOROUS, AND HEALTHY GROWTH OF ALL MATERIAL PLANTED. ALL STAKES, WIRE, HOSE, AND OTHER ACCESSORIES MUST BE REMOVED PRIOR TO FINAL WARRANTY INSPECTION.
- 12. ALL PLANT MATERIAL USED AS REPLACEMENTS FOR UNACCEPTABLE MATERIAL SHALL BE OF THE SAME QUALITY AND REQUIREMENTS PRESCRIBED FOR THE ORIGINAL MATERIAL. REPLACEMENTS SHALL BE MADE ONCE UNDER THE WARRANTY.

- 1.0 GROWING MEDIUM TESTING:
- 1.1 GROWING MEDIUMS (TOPSOIL; PLANTING MIXES) AND ORGANIC AMENDMENTS MUST BE TESTED BY AN OMAFRA ACCREDITED AGENCY AND APPROVED PRIOR TO USE. TEST TOPSOIL FOR P, K, CA AND MG, MINOR ELEMENT VALUES, SOLUBLE SALT

  4.2 FERTILIZER: COMPLETE COMMERCIAL FERTILIZER WITH 50% OF THE ELEMENTS CONTENT, ORGANIC MATTER, TEXTURE AND PH VALUE APPROPRIATE FOR THE ESTABLISHMENT AND GROWTH OF ORNAMENTAL NURSERY STOCK. SUBMIT TEST RESULTS AND ANALYSIS INCLUDING RECOMMENDATIONS FOR AMENDMENTS AND FERTILIZER TO THE CONSULTANT.

### 2.0 TOPSOIL:

- 2.1 TOPSOIL SHALL BE FERTILE, FRIABLE, TOPSOIL, FREE OF: FRAGMENTS LARGER THAN 75MM IN SIZE; STONES OVER 30MM IN DIAMETER; DEBRIS; PLANTS OR THEIR ROOTS; STICKS; NOXIOUS SEED PLANTS; STOLONS; SEEDS; SALTS; SOIL STERILANTS; CHEMICAL CONTAMINANTS; O OTHER MATERIALS DETRIMENTAL TO PLANT GROWTH.
- 2.2 FERTILIZER AND AMENDMENTS: MUST BE MADE AS PER SOIL TESTING AGENCY
- 2.3 ALL TOPSOIL FOR THE INTENSIVE USE LAWN AREAS SHALL BE SANDY LOAM CLASS ONLY.
- 2.4 TOPSOIL: SHALL NOT BE MOVED, DELIVERED OR WORKED ON WHILE IN A FROZEN STATE OR CONDITION.


### 3.0 GROWING MEDIUM - PLANTING MIXES:


- 3.1 PLANTING MIX: (WHERE SPECIFIED) SHALL BE THOROUGHLY COMBINED PRIOR TO PLACEMENT IN PLANTING BED AREAS TO THE FOLLOWING PROPORTIONS: 4 PARTS APPROVED TOPSOIL, 1 PART COMPOST, 1 PART SHREDDED PEAT MOSS AND

  4.6 BONEMEAL: RAW, FINELY GROUND WITH A MINIMUM ANALYSIS OF 4% NITROGEN AN APPLICATION OF HIGH PHOSPHOROUS FERTILIZER (0-20-0).
- 3.2 MIXES CONTAINING A SIGNIFICANT AMOUNT OF PEAT MOSS SHALL NOT BE PERMITTED TO DRY OUT. THE MOISTURE CONTENT OF THE PEAT MOSS AT THE TIME OF MIXING SHALL BE NOT LESS THAN 60% TO 75%.

- 4.1 ORGANIC SOIL ADDITIVE: "GRO-BARK" FINE COMPOSTED PINE MULCH OR AN APPROVED ALTERNATIVE.
- DERIVED FROM ORGANIC SOURCES.
- 4.3 PEAT MOSS: DECOMPOSED PLANT MATERIAL, FAIRLY ELASTIC AND HOMOGENOUS, FREE OF DECOMPOSED COLLOIDAL RESIDUE, WOOD, SULPHUR AND IRON AND OF BROWN COLOUR CONTAINING MINIMUM 60% ORGANIC MATTER BY WEIGHT, MOISTURE CONTENT NOT EXCEEDING 15% AND PH VALUE OF 3.4 - 5.5.
- 4.4 COMPOST AND MANURE: SHALL MEET THE STANDARDS FOUND IN THE INTERIM GUIDELINES FOR THE PRODUCTION AND USE OF AEROBIC COMPOST IN ONTARIO PUBLISHED BY THE ONTARIO MINISTRY OF ENVIRONMENT AND ENERGY (MOEE). AND SHALL BE VIRTUALLY FREE FROM ALL VIABLE WEED SEEDS. OR OTHER PLANT REPRODUCTIVE PARTS. PATHOGENS. CHEMICALS OR TOXIC CONTAMINATES. MANURE SHALL BE WELL ROTTED, UNBLEACHED CATTLE MANURE, FREE FROM HARMFUL CHEMICALS AND OTHER INJURIOUS SUBSTANCES, AT LEAST EIGHT MONTHS OLD, BUT NOT MORE THAN TWO YEARS OLD AND WITH NO MORE THAN 25% STRAW, LEAVES OR OTHER MATERIALS. PHYSICAL CONTAMINATES SUCH AS ROCK, PLASTIC, METAL OR GLASS SHALL BE LESS THAN 0.5%. TOTAL CARBON TO NITROGEN RATIO IN THE RESULTING GROWING MEDIUM SHALL NOT EXCEED 30:1.
- 4.5 LIME: LIMESTONE CONTAINING NOT LESS THAN 8% OF CALCIUM AND MAGNESIUM CARBONATES COMBINED, FINELY GROUND TO PASS A 10 MESH SIEVE WITH AT LEAST ONE HALF PASSING A 100 MESH SIEVE. RATE OF APPLICATION SHALL BE DETERMINED AFTER THE PH OF THE TOPSOIL.
- AND 20% PHOSPHORIC ACID.
- 4.7 SAND: SHARP, CLEAN SAND, TO OPSS 1002-3.


DECIDUOUS TREES	QTY	BOTANICAL NAME	COMMON NAME	CONT	CAL		REMARKS
LT	5	Liriodendron tulipifera	Tulip Tree	W.B.	60mm Cal		
QMA	6	Quercus macrocarpa	Burr Oak	W.B.	60mm Cal		
QR	2	Quercus rubra	Red Oak	W.B.	60mm Cal		
TA	7	Tilia americana	Basswood	W.B.	60mm Cal		
CONIFEROUS SHRUBS	QTY	BOTANICAL NAME	COMMON NAME	CONT		SPACING	REMARKS
JsA	40	Juniperus sabina `Arcadia`	Arcadia Juniper	50cm, 3 gal.		1m	
TmD	12	Taxus x media `Densiformis`	Dense Yew	50cm, 3 gal.		1.50m	
DECIDUOUS SHRUBS	QTY	BOTANICAL NAME	COMMON NAME	CONT		SPACING	REMARKS
Aca	4	Amelanchier canadensis	Canadian Serviceberry	Clump 150cm 7 gal		4m	multi-stem clump
HpB	79	Hydrangea paniculata `Bombshell`	Bombshell Hydrangea	60cm, 3 gal.		1m	'
SjL	23	Spiraea japonica `Little Princess`	Little Princess Japanese Spirea	60cm, 3 gal.		0.70m	
SyP	7	Syringa meyeri `Palibin`	Dwarf Korean Lilac	60cm, 3 gal.		1.20m	
ODNIAMENTAL ODACCEC	OTV	DOTANICAL NAME	CONMINACIONALINIANAE	CONT		CDACING	DEMARKS
ORNAMENTAL GRASSES	QTY	BOTANICAL NAME	COMMON NAME	CONT		SPACING	REMARKS
msL	46	Calamagrostis acutiflora `Karl Foerster` Miscanthus sinensis `Little Kitten`	Feather Reed Grass  Little Kitten Eulalia Grass	1 gal		0.70m 0.60m	
PERENNIALS	QTY	BOTANICAL NAME	COMMON NAME	CONT		SPACING	REMARKS
hol	42	Hosta lancifolia	Narrow Leaved Hosta	1 gal		750mm	
hPD	239	Hemerocallis x `Purple D`oro`	Purple D`oro Daylily	1 gal		450mm	
hSR	177	Hemerocallis x `Stella In Red`	Stella In Red Daylily	1 gal		450mm	

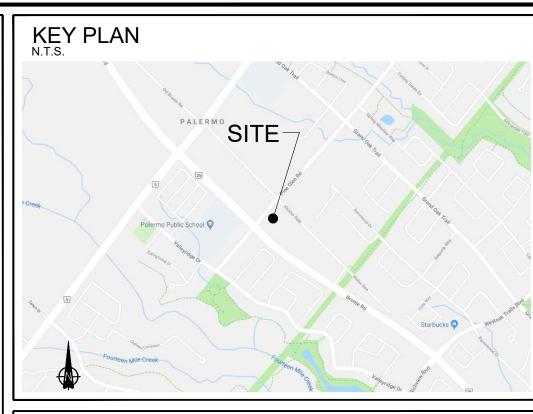

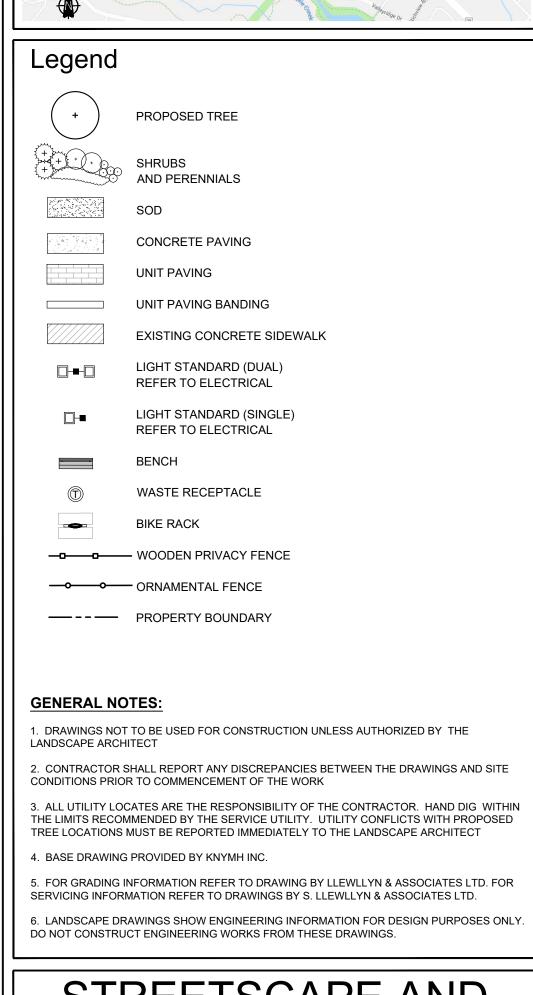



2418 KHALSA GATE OAKVILLE, ON.

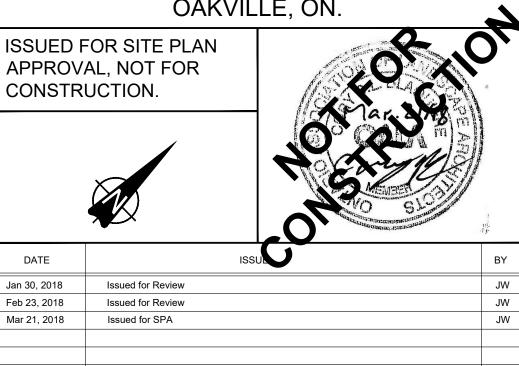



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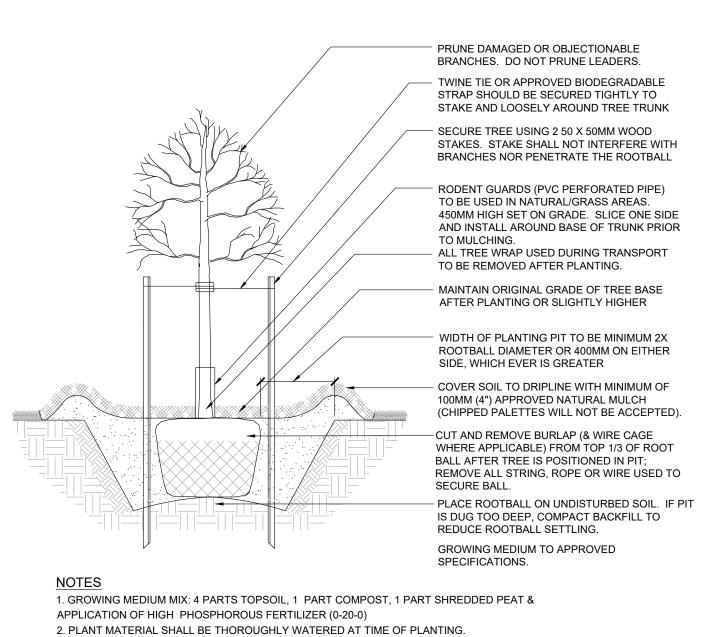


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Date: March 14, 2018 Drawn By: JW Scale: 1:200 Project No.: 17251






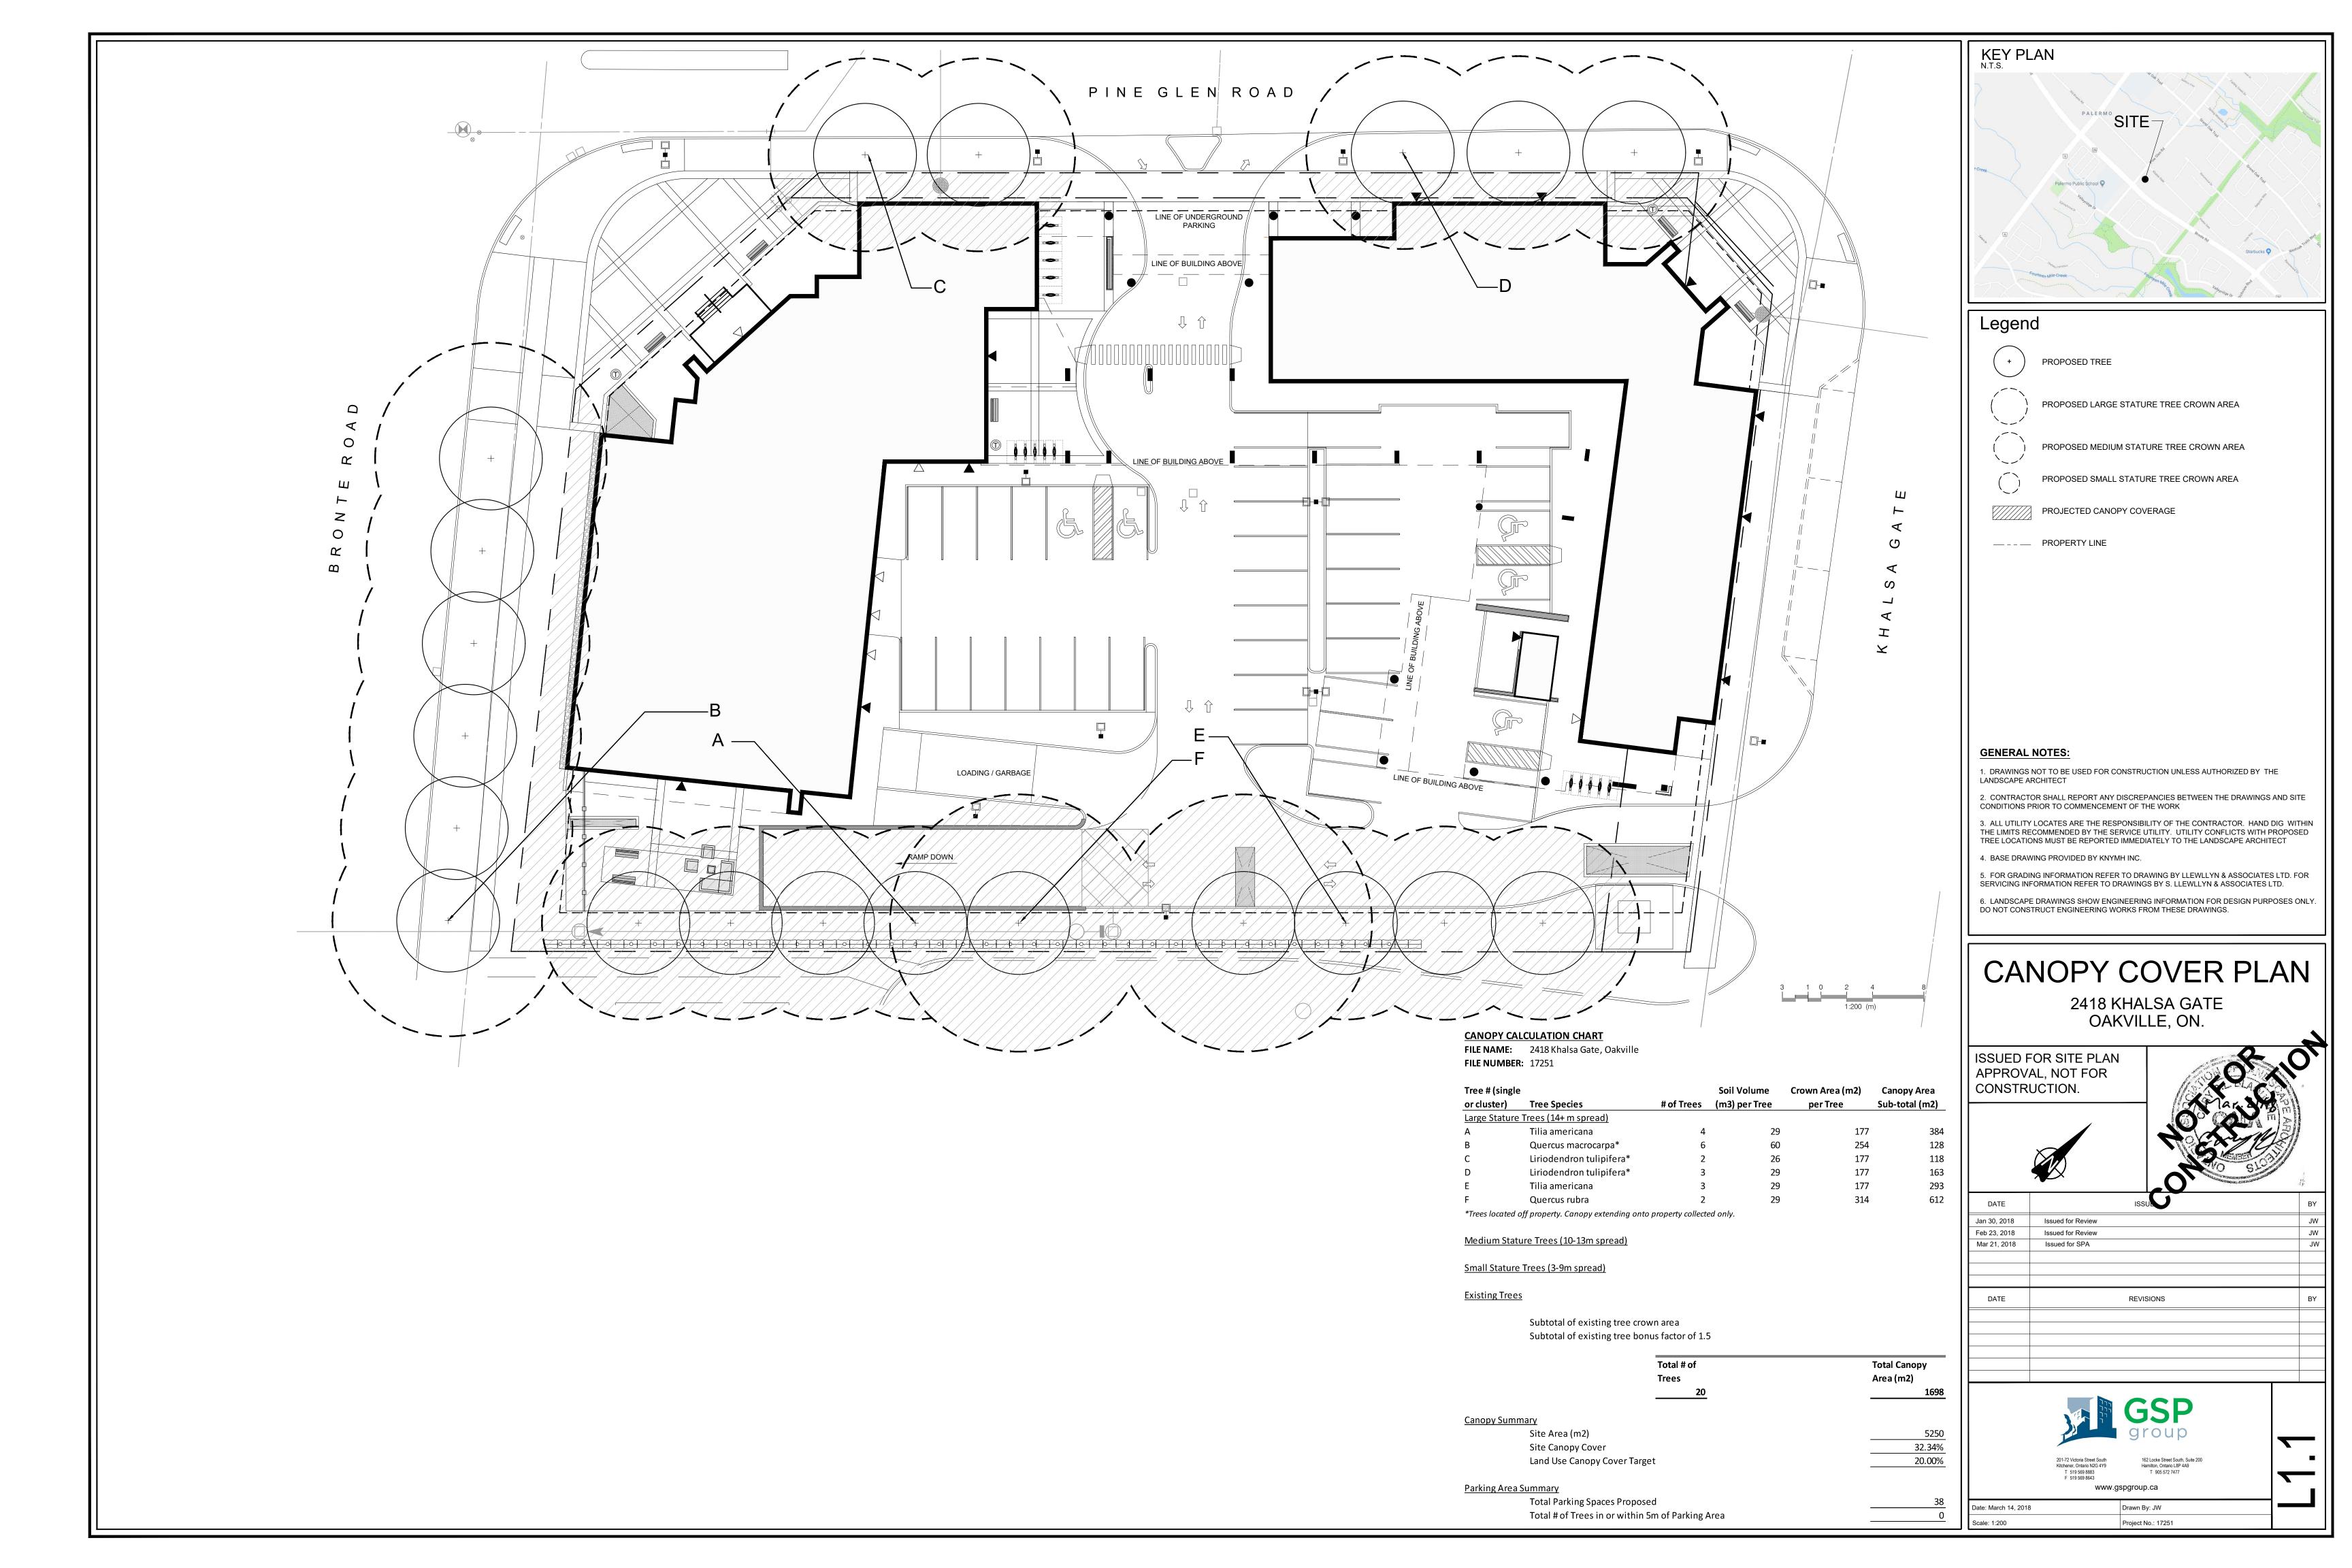

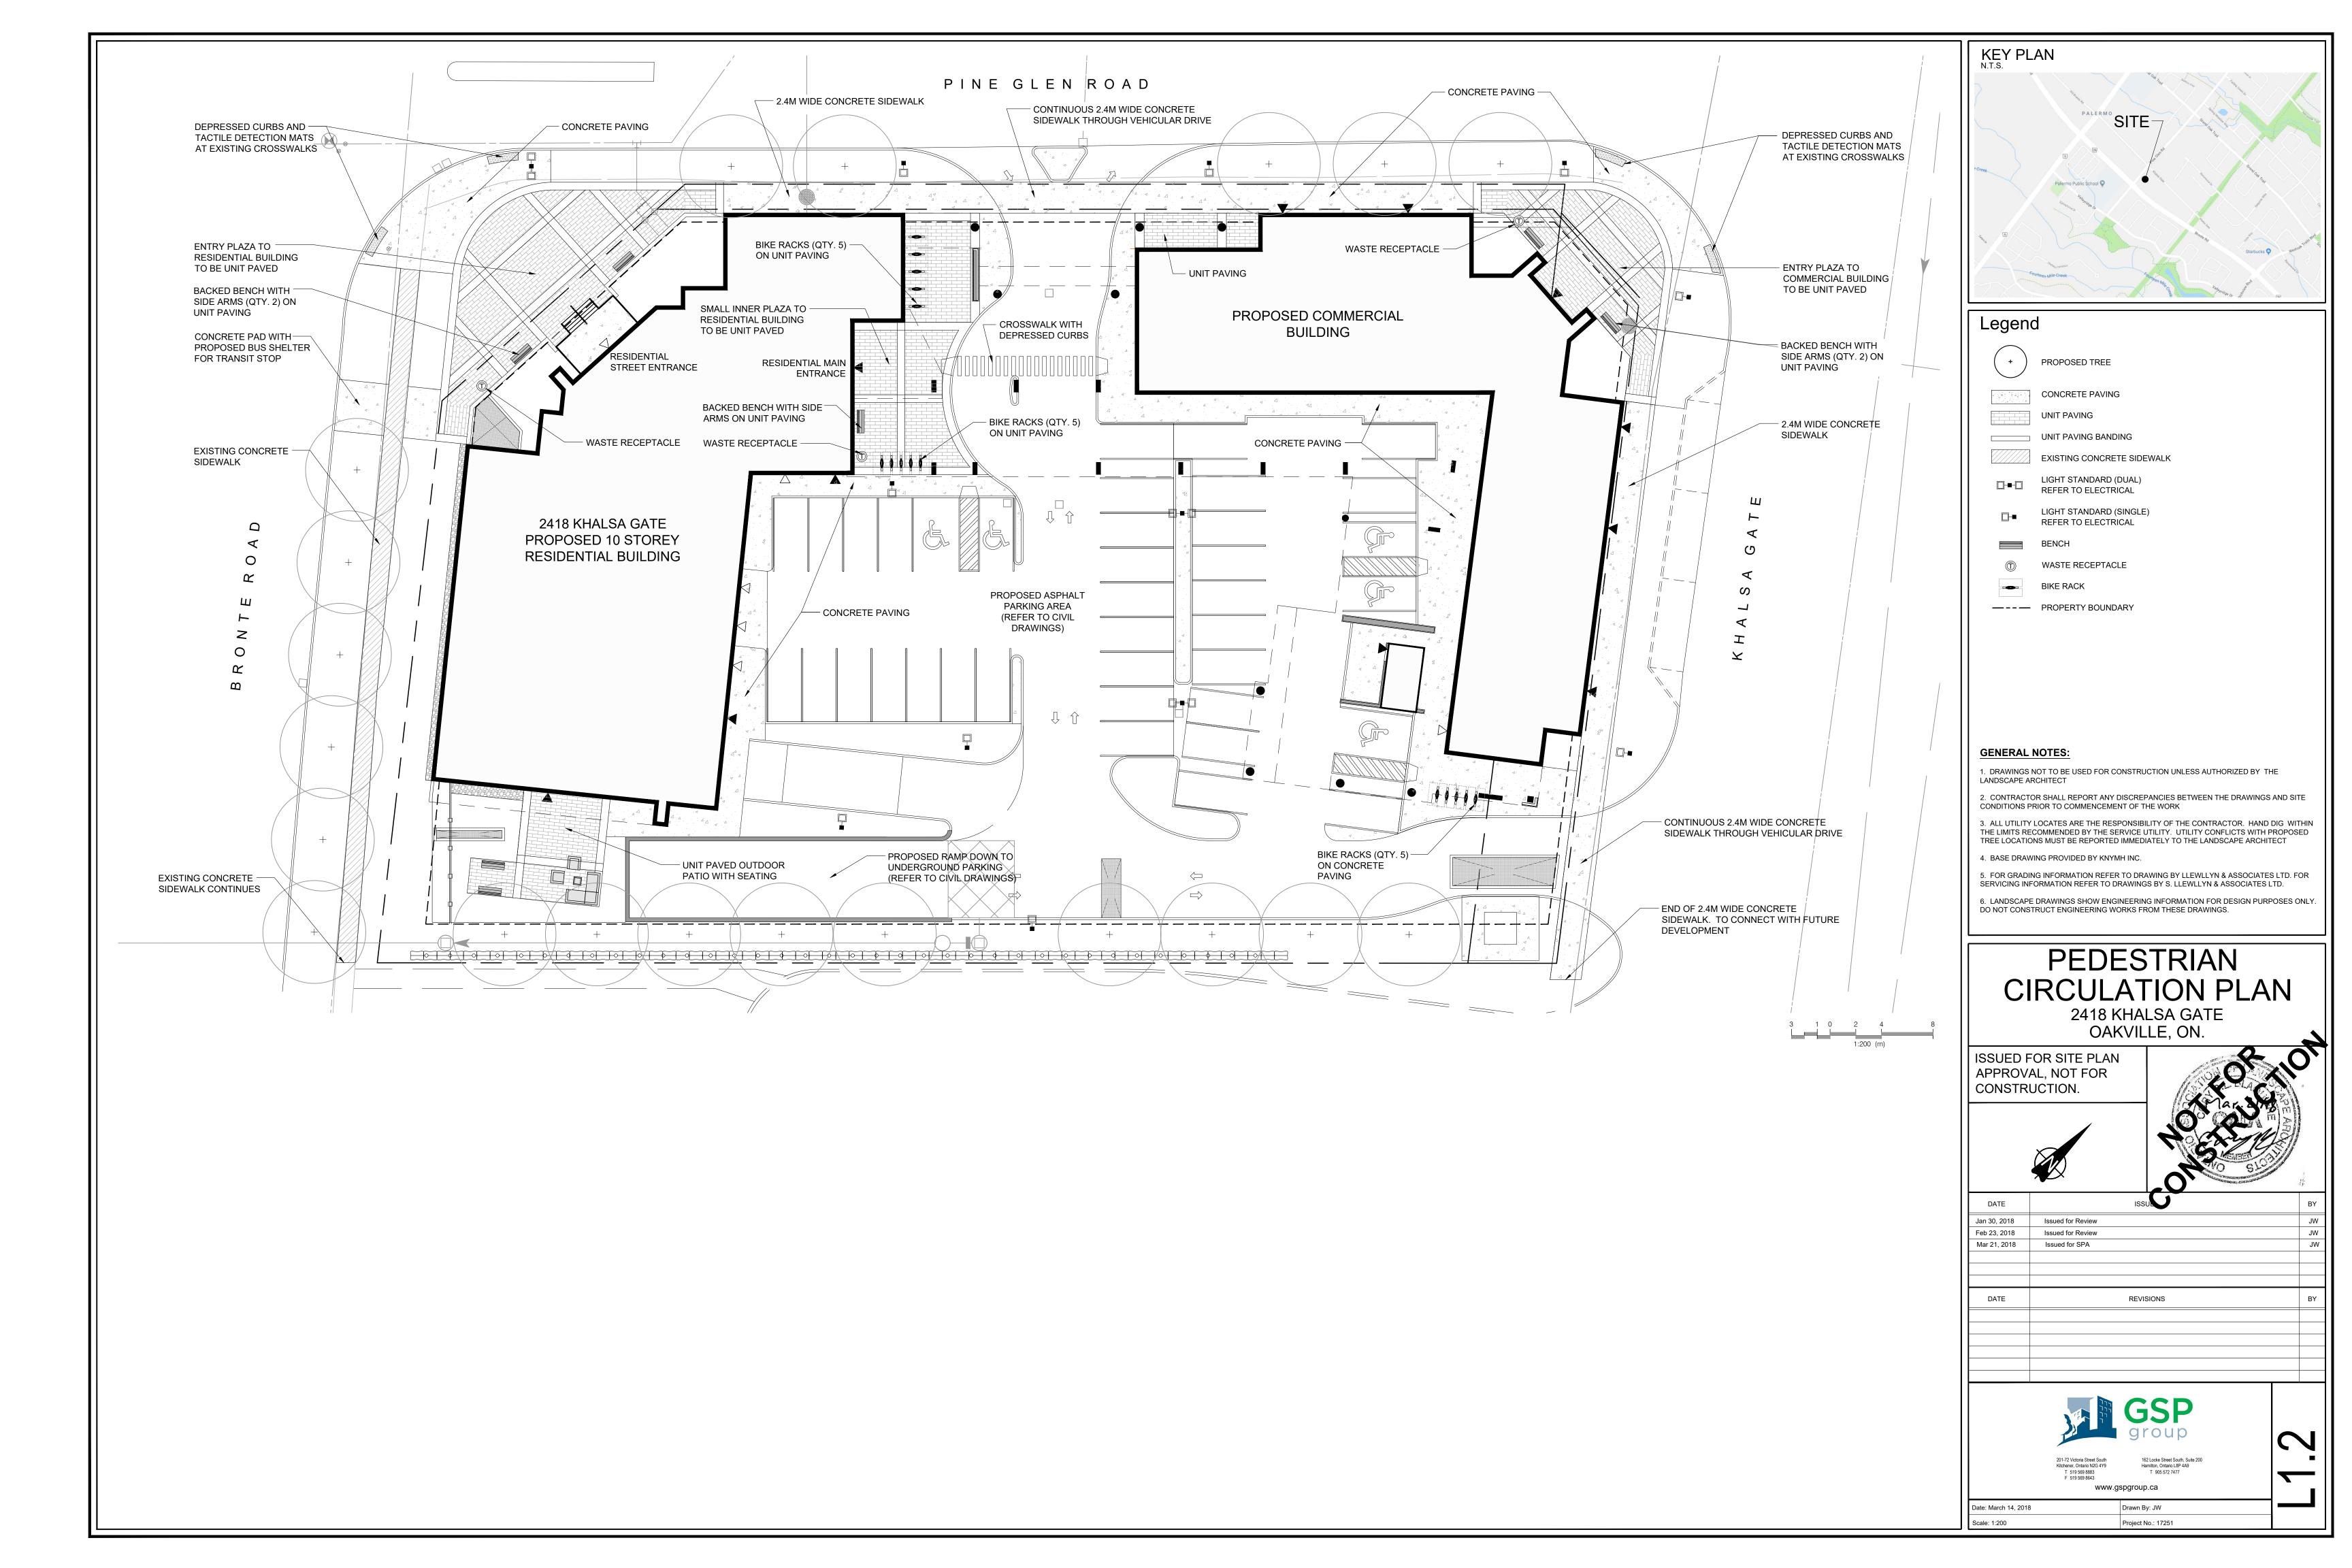- 3. PLANT MATERIAL SHALL BE SET PLUMB IN THE MIDDLE OF THE PIT.
- 4. TREE SHALL BEAR SAME RELATION OR SLIGHTLY HIGHER TO FINISHED GRADE AS ORIGINALLY
- 5. PLANT STOCK MOVED WHILE IN LEAF SHALL BE COVERED WHILE IN TRANSIT. ROOTS SHOULD BE
- KEPT MOIST UNTIL PLANTED. TREES IN LEAF TO BE TREATED WITH ANTI-DESICANT. 6. DIMENSIONS ARE IN MILLIMETERS UNLESS OTHERWISE NOTED.
- 7. STAKING IS TO OCCUR ONLY AT THE DIRECTION OF THE LANDSCAPE ARCHITECT.
- 8. 100MM HIGH SAUCER EXCEPT WHEN PLANTING IN BED.

# DECIDUOUS TREE PLANTING B.B/W.B - UP TO 80mm CALIPER

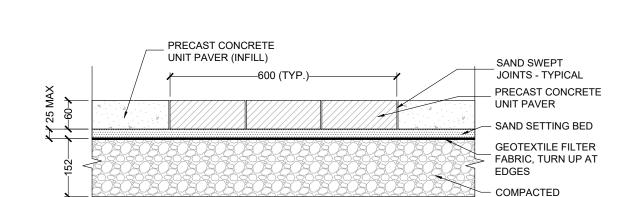


CRUSHED STONE

COMPACTED

SUBGRADE

## UNIT PAVING BANDING

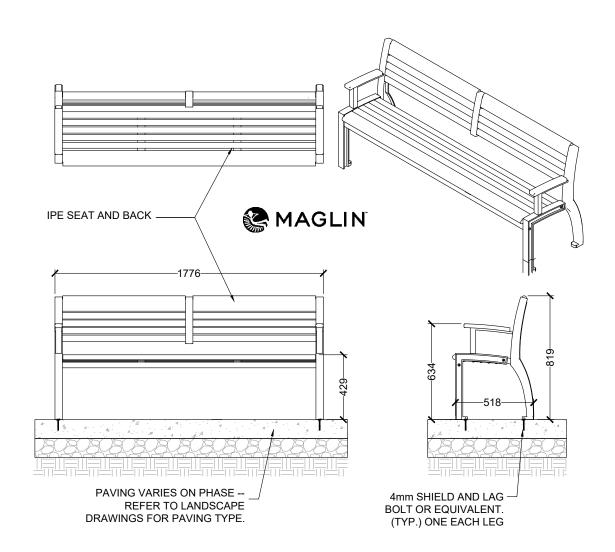

BENCH TYPE 'B', NO. MLB700-W-A, BACKED WITH SIDE ARMS, BY MAGLIN SITE FURNITURE OR APPROVED EQUAL 27 BYSHAM PARK DRIVE, WOODSTOCK, ON N4T 1P1

BENCH TYPE 'A', NO. MLB700-W-A, BACKED WITHOUT SIDE ARMS, WITH CENTER ARM, BY MAGLIN SITE FURNITURE OR APPROVED EQUAL 27 BYSHAM PARK DRIVE, WOODSTOCK, ON N4T 1P1

1-800-716-6606 WWW.MAGLIN.COM ARM POWDERCOAT COLOUR: BLACK FINETEX

SURFACE MOUNT TO CONCRETE PAD THROUGH HOLES IN FEET AS PER MANUFACTURER'S RECOMMENDATIONS.

BACKED WOOD BENCH - MAGLIN 700-W-A

EP3630 WASTE RECEPTACLE

This waste receptacle must be anchored.

QS 4 stainless steel kwik bolts

CONCRETE SLABS AND ANCHORS

**Equiparc** 

EP 3630

SPECIFICATIONS

Galvanized liner: 91 litres / 24 US gal

Waste receptacle

Zinc rich primer and polyester powder coated BLACK FINISH

Flats and plates made of welded steel

Recycling unit with descriptive panels.

Depth or Length.: 533mm (21") Height.: 840mm (33")

Our warranty applies when our product is properly assembled and anchored


1 slab 610mm X 610mm X 152mm (24" X 24" X 6")

QAV 4 drop-in anchors with stainless steel theftproof bolts

Aluminum, powder coat finish BLACK FINISH

25mm X 152mm (1" X 6")

# TYPICAL PLANTING BED EDGE

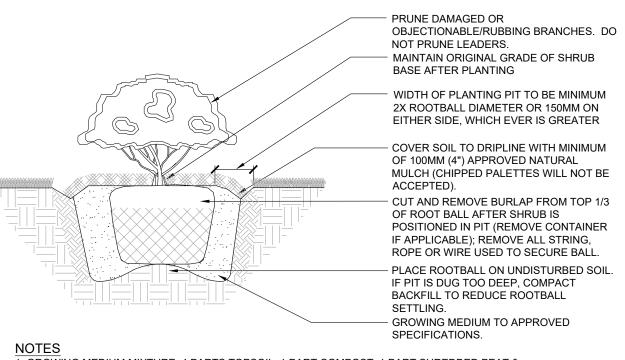


1. GROWING MEDIUM MIXTURE: 4 PARTS TOPSOIL, 1 PART COMPOST, 1 PART SHREDDED PEAT & APPLICATION OF HIGH PHOSPHOROUS FERTILIZER (0-20-0). 2. PLANTING BED SHALL BE THOROUGHLY WATERED IMMEDIATELY AFTER PLANTING & PRIOR TO

3. FOR POTTED SHRUBS, SATURATE CONTAINER/ ROOTS/SOIL PRIOR TO REMOVAL OF CONTAINER


4. SHRUBS ARE TO BE SPACED AS DIRECTED. 5. ALL DIMENSIONS ARE IN MILLIMETERS.

# → B&B/CONTAINER STOCK SHRUB PLANTING

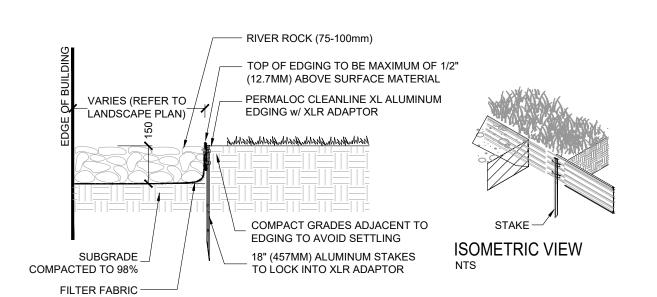

- 1. INSTALL PER MANUFACTURER'S "INSTALLATION GUIDELINES" 2. 8'-0" (2.44 M) SECTIONS TO INCLUDE (3) 18" (457 MM) ALUMINUM STAKES AND (3) XLR ADAPTORS. 3. 16'-0" (4.88 M) SECTIONS TO INCLUDE (5) 18" (457 MM) ALUMINUM STAKES AND (3) XLR ADAPTORS. 4. CORNERS - CUT BASE EDGING UP HALFWAY AND FORM A CONTINUOUS CORNER.
- 5. PERMALOC CLEANLINE XL AS MANUFACTURED BY PERMALOC CORPORATION, HOLLAND MI. (800) 6. CONTRACTOR'S NOTE: FOR PRODUCT AND PURCHASING INFORMATION VISIT: WWW.PERMALOC.COM



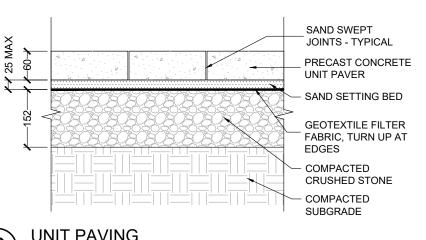

 CONCRETE PAVING TO BE BROOM FINISHED, NATURAL COLOUR. REFER TO LANDSCAPE PLAN (SHEET L1.0) FOR CONCRETE PAVING LOCATIONS. EXPANSION JOINT - AS TWO PART POLYSULFIDE JOINT SHOWN OR AT ALL COLD - SEALANT MAX. 15 DEPTH OVER JOINTS OR PERIMETER BACKER ROD. **BOUNDARIES WITH OTHER** STRUCTURES OF PAVING. **PEDESTRIAN VEHICULAR** APPLICATION 7 APPLICATION - BACKER ROD ASPHALT-IMPREGNATED CONTROL/DECORATIVE FIBREBOARD JOINT FILLER JOINT, AS SHOWN OR - 32 MPA CONCRETE -EVERY 6M MAX. CLEAN -SAWCUT JOINTING ONLY. REINFORCING STEEL TO 25 MAX. DEPTH.

COMPACTED SUBGRADE -


--- GRANULAR `A' COMPACTED TO 98% S.P.D.


ON CENTRE WITH CROSSWALK **CURB - REFER TO** CIVIL DRAWINGS DURALAST DETECTABLE WARNING PLATES, AS SUPPLIED BY EJA USA INC. (OR APPROVED EQUIVALENT) - SET 4 PANELS O/C WITH CROSSWALK (24x24") TO BE SET INTO CONCRETE. - COLOR TO BE: UNFINISHED - CONTRACTOR TO SUBMIT SHOP DRAWINGS OF LAYOUT FOR LANDSCAPE ARCHITECT APPROVAL PRIOR TO STARTING CONSTRUCTION CONCRETE PAVING (REFER TO DETAIL 2, SHEET 2.0)

TACTILE WARNING PLATES (IN CONCRETE) LAYOUT
1:25

# CONCRETE PAVING (PEDESTRIAN AND VEHICULAR)



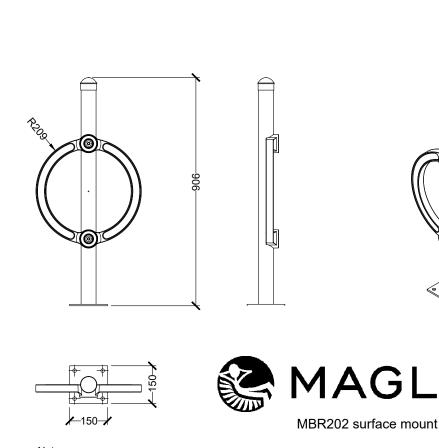

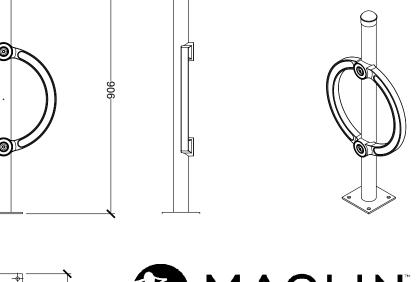




1. All dimensions are in mm 2. All steel components are maglin powder coated as per manufacturers specifications. 3. Bike rack colour to be black. Colour sample to be approved by Landscape Architect prior to installation. 4. The bike rack is delivered pre-assembled. Holes (8mm) are provided in each foot for securing to base. Contractor to provide hardware for installation 5. Refer to manufacture's specification on installation. Paving varies on phase; refer to landscape

Name 
Na

drawings for paving type and layout.

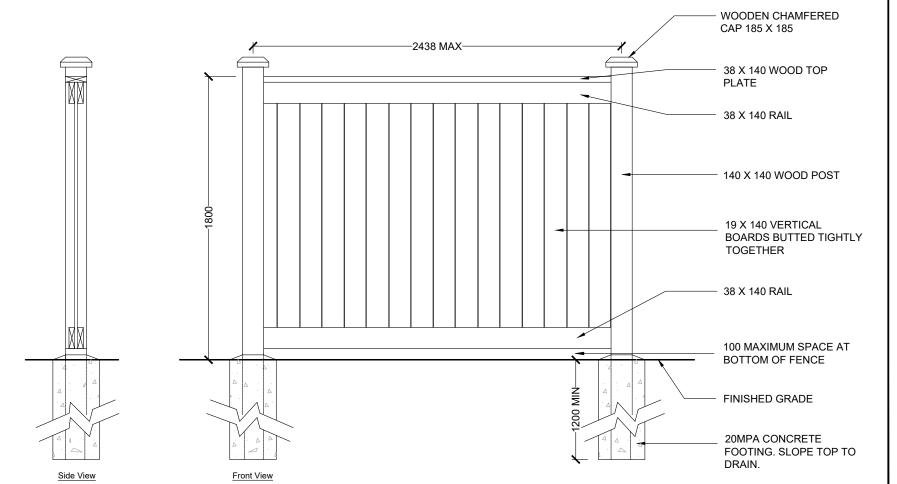

Dimensional | Metric (Nominal)

1" = 19mm

1.5" = 25mm

2" = 38mm

4" = 89mm

6" = 140mm

8" = 190mm

Scale: As Shown

SPECIFICATIONS: 1. ALL WOOD TO BE NO. 1 CONSTRUCTION GRADE CEDAR, OR PRESSURE-TREATED AS DETERMINED BY OWNER, AND FREE OF EXCESSIVE CHIPS, CRACKS, WARPS OR KNOTS. 2. ALL FASTENERS TO BE HOT DIPPED GALVANIZED 3. ALL CUTS TO PRESSURE-TREATED WOOD MUST BE TREATED WITH TWO LIBERAL BRUSH COATS OF COPPER-BASED PRESERVATIVE. PRESSURE-TREATED FENCING WITHOUT SUCH TREATMENT WILL NOT BE

9 WOOD PRIVACY FENCE
Scale 1:25

ACCEPTED.

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# DETAILS

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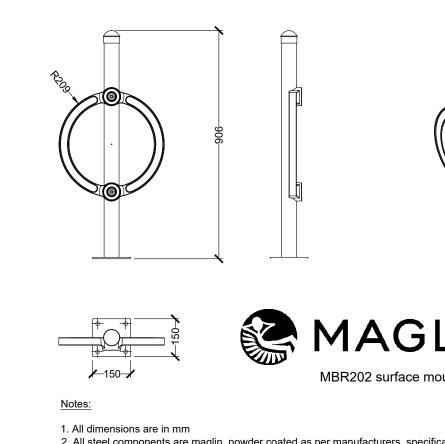
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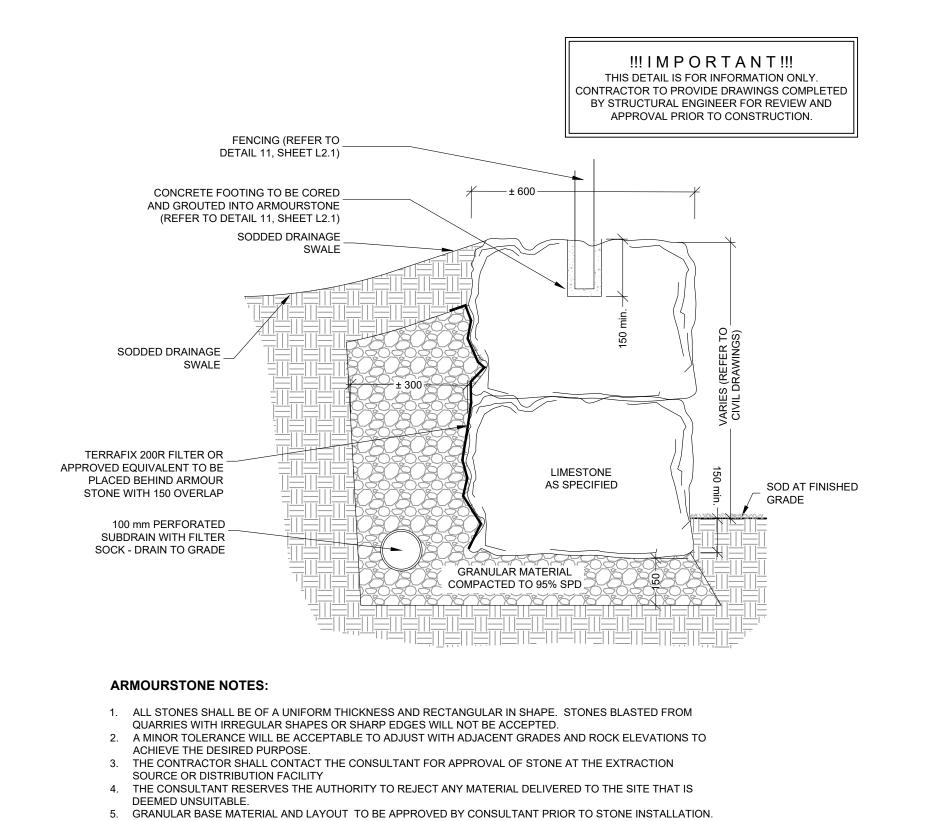


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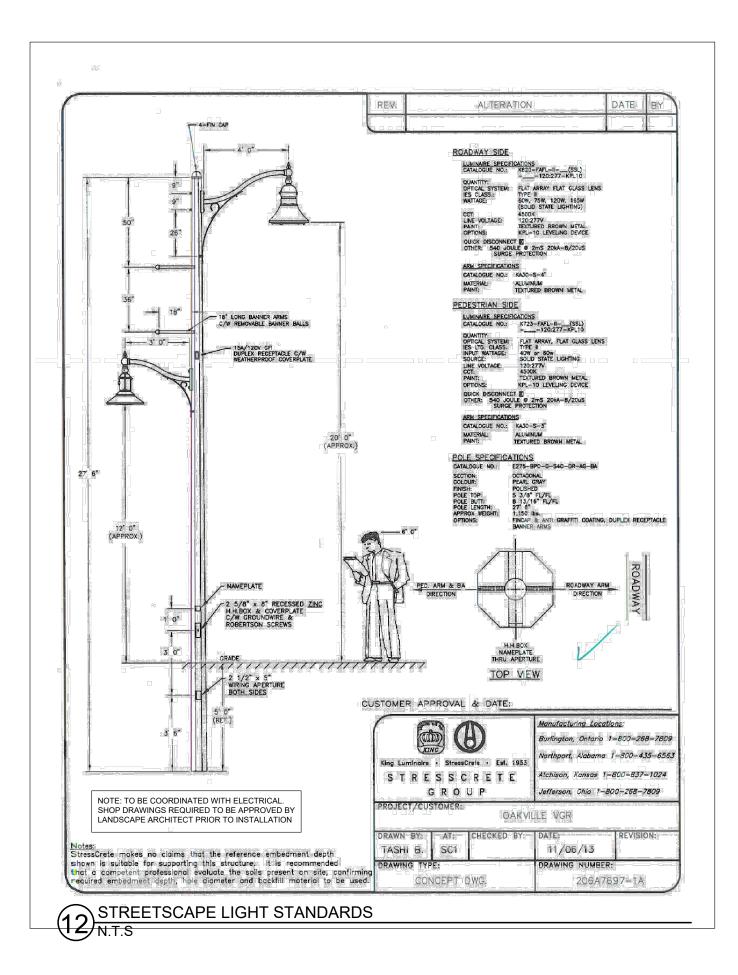


ARMOURSTONE RETAINING WALL
Scale 1:10

!!! I M P O R T A N T !!! THIS DETAIL IS FOR INFORMATION ONLY. CONTRACTOR TO PROVIDE DRAWINGS COMPLETED BY STRUCTURAL ENGINEER FOR REVIEW AND APPROVAL PRIOR TO CONSTRUCTION. POST SETTING 1892mm (74 1/2") CENTRE TO CENTRE PANEL WIDTH 1765mm (69 1/2") MAX.

NOTE: PANELS MAY BE CUT TO SUIT BALL POST CAP OR PYRAMID 95mm CLEAR BETWEEN PICKETS - CORE AND GROUT MIN. DISTANCE FROM ARMOUR STONE EDGE – 150mm PRE-PUNCHED RAILS FOR —— CONCRETE FOOTING PICKET INSERTION ARMOURSTONE WALL (REFER TO DETAIL 10, SHEET 2.1) SPECIFICATIONS: POSTS, RAILS PANEL WIDTH OF 1765mm (69 1/2") & PICKETS PANLE HEIGHT OF 1219mm (48") POST CAP: PYRAMID OR BALL 38mm x 64mm (1 1/2" x 2 1/2") , 16 GAUGE COLD FORMED STEEL TUBING INTERIOR & EXTERIOR GALVALUME COATING PICKETS: 19mm x 38mm (3/4" x 1 1/2"), 16 GAUGE CHROMATE CONVERSION COATING ELECTROSTATICALLY APPLIED FITTINGS: 12 GAUGE STAMP FORGED THERMALLY BONDED POLYESTER POWDER COATING FACTORY FINISH AS ABOVE MINIMUM FILM THICKNESS 2.5 mils 76mm x 76mm (3"x3"), 14 GAUGE OR SCH 40 WELDS: STAINLESS STEEL POST SPACING (CENTRE TO CENTRE): WARRANTY: 5 YEAR MAINTENANCE FREE 1765mm (69 1/2") POST FLANGE**3**03mm x 203mm (8"x8") x 13mm (1/2") 254mm x 254mm (10"x10") x 13mm (1/2")

11 IRON FENCE ON ARMOURSTONE DETAIL Scale 1:20



### **GENERAL NOTES:**

- 1. DRAWINGS NOT TO BE USED FOR CONSTRUCTION UNLESS AUTHORIZED BY THE LANDSCAPE ARCHITECT
- 2. CONTRACTOR SHALL REPORT ANY DISCREPANCIES BETWEEN THE DRAWINGS AND SITE CONDITIONS PRIOR TO COMMENCEMENT OF THE WORK
- 3. ALL UTILITY LOCATES ARE THE RESPONSIBILITY OF THE CONTRACTOR. HAND DIG WITHIN THE LIMITS RECOMMENDED BY THE SERVICE UTILITY. UTILITY CONFLICTS WITH PROPOSED
- TREE LOCATIONS MUST BE REPORTED IMMEDIATELY TO THE LANDSCAPE ARCHITECT 4. BASE DRAWING PROVIDED BY KNYMH INC.
- 5. FOR GRADING INFORMATION REFER TO DRAWING BY LLEWLLYN & ASSOCIATES LTD. FOR SERVICING INFORMATION REFER TO DRAWINGS BY S. LLEWLLYN & ASSOCIATES LTD.
- 6. LANDSCAPE DRAWINGS SHOW ENGINEERING INFORMATION FOR DESIGN PURPOSES ONLY. DO NOT CONSTRUCT ENGINEERING WORKS FROM THESE DRAWINGS.

# **DETAILS**

2418 KHALSA GATE OAKVILLE, ON.

ISSUED FOR SITE PLAN APPROVAL, NOT FOR CONSTRUCTION.

Jan 30, 2018 Issued for Review Feb 23, 2018 Issued for Review Mar 21, 2018 Issued for SPA DATE REVISIONS

Date: March 14, 2018 Drawn By: JW Scale: As Shown Project No.: 17251

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