UNDERGROUND LAYOUT GROUND FLOOR PLAN A102

A103 SECOND FLOOR PLAN THIRD - FIFTH FLOOR PLAN A104 A105 SIXTH FLOOR PLAN

SEVENTH FLOOR PLAN EIGHTH - NINTH FLOOR PLAN A107

A108 **ROOF PLAN**

BUILDING ELEVATIONS A201 **BUILDING ELEVATIONS**

A301 **BUILDING SECTIONS** A302 **BUILDING SECTIONS**

A501 SHADOW STUDY - APRIL A502 SHADOW STUDY - JUNE

A503 SHADOW STUDY - MARCH/SEPTEMBER A504

SHADOW STUDY - DECEMBER

3D PERSPECTIVE VIEWS A601 A602 3D PERSPECTIVE VIEWS **OWNER**

Branthaven Homes

720 Oval Court Burlington, Ontario, L7L 6A9 Contact: Anthony Girolami Tel: 905-333-8364 Fax: 905-333-1720

ARCHITECT

Michael Spaziani Architect INC.

6 Helene St. North, Unit 100 Mississauga, Ontario, L5G 3B2 Contact: Jason DeBrum Tel: 905-891-0691 Ext. 7 Fax: 905-891-0541

LANDSCAPE ARCHITECT

Adesso Design Inc.

218 Locke St. South Hamilton, Ontario, L8P 4B4 Contact: Matthew Madigan Tel: 905-526-8876 Ext. 202

CIVIL ENGINEER

WSP Engineering Consulting Service

148 Coastline Dr. Brampton, Ontario, L6Y 0S2 Contact: Au Lu Tel: 289-982-4308

PLANNER

Ruth Victor & Associates

1243 Valleybrook Drive, Oakville, Ontario, L6H 4Y1 Contact: Ruth Victor Tel: 905-257-3590 Fax: 905-257-1521

TRAFFIC ENGINEER

GHD

6705 Millcreek Drive, Unit 1 Mississauga, Ontario, L5N 5M4 Contact: Scott Henderson Tel: 905-526-8876

SOIL ENGINEER

Soil-Mat Engineers & Consultants Ltd.

130 Lancing Dr., Unit 1 Hamilton, Ontario, L8W 3A1 Contact: Ian Shaw Tel: 905-318-7440 Fax: 905-318-7455

ENVIRONMENTAL ENGINEER

Beacon Environmental

373 Woolwich Street Guelph, Ontario, N1H 3W4 Contact: Ken Ursic Tel: 519-826-0419

MCCRANEY RETIREMENT RESIDENCE

Branthaven McCraney Inc. 1105 McCraney Street East Oakville, Ontario

ISSUED FOR:

ISSUED FOR SPA ISSUED FOR COORDINATION ISSUED FOR 50% COMPLETION

ISSUED FOR 75% COMPLETION ISSUED FOR FINAL COORDINATION

ISSUED FOR TENDER ISSUED FOR FOUNDATION BUILDING PERMIT

ISSUED FOR BUILDING PERMIT REVIEW ISSUED FOR BUILDING PERMIT

ISSUED FOR CONSTRUCTION

AS NOTED AS-BUILT

DATE: July 2019 PROJECT No. C8046



6 Helene Street N, Suite 100

Port Credit, Mississauga ON L5G 3B2

NOTE: This drawing is the property of the Architect and may not be reproduced or used without the expressed consent of the Architect. The contractor

CLIENT:

Branthaven McCraney

Oakville, Ontario

PROJECT:

McCraney Retirement Residence


1105 McCraney Street East Oakville, Ont. SP1514021/01

SHEET TITLE: Cover

PROJECT NO. C8046 DATE: SCALE: 1:300 DRAWN:


July 2019 SHEET NO: CHECKED: A000 FILE NO. C8046

1105 MCCRANEY STREET EAST, OAKVILLE, ON ONTARIO BUILDING CODE (2012) OBC REFERENCE DATA MATRIX PARTS 3 & 9 References are to Division B unless noted [A] for PART 3 PART 9 PROJECT DESCRIPTION: NEW ☐ PART 11 11.1 TO 11.4 1.1.2 [A] 2.1.1 [A] ADDITION ALTERATION 9.10.1.3 CHANGE OF USE 2 MAJOR OCCUPANCY(S) GROUP C- RESIDENTIAL (RETIREMENT HOME) 9.10.2 3 BUILDING AREA (SQ. M.) 1.4.1.2 [A] EXISTING 0 4 GROSS AREA OF SUITE 1.4.1.2 [A] EXISTING 0 NEW 25,070.0 SM TOTAL 25,070.0 SM 1.4.1.2 [A] 1.4.1.2 [A] & 3.2.1.1 1.4.1.2 [A] & NUMBER OF STOREYS ABOVE GRADE 9 BELOW GRADE NUMBER OF STREETS/FIRE FIGHTER ACCESS 3.2.2.10 & 3.2.5 9.10.20 3.2.2.48A - GROUP C -RETIREMENT 7 BUILDING CLASSIFICATION 3.2.2.20-.83 SPRINKLER SYSTEM PROPOSED ■ ENTIRE BUILDING 3.2.2.20 - .83 9.19.8.2 ☐ SELECTED COMPARTMENTS ☐ SELECTED FLOOR AREAS BASEMENT IN LIEU OF ROOF RATING 9 STANDPIPE REQUIRED 10 FIRE ALARM REQUIRED 9.10.18 11 WATER SERVICES/SUPPLY IS ADEQUATE 3.2.5.7 N/A NON ☐ COMBUSTIBLE ■ BOTH CONSTRUCTION RESTRICTIONS REQUIRED 3.2.2.20-.83 COMBUSTIBLE ACTUAL CONSTRUCTION ☐ COMBUSTIBLE ■ BOTH 14 MESSANINE(S) AREA (SQ. M.) 3.2.1.1.(3)-(8) 9.10.6 15 OCCUPANT LOAD BASED ON SQ. M./PERSON DESIGN OF BUILDING 9.9.1.3 OCCUPANT LOAD FLOOR OCCUPANCIES **FACTOR** AREA (SM) (PERSONS) BASEMENT GROUND FLOOR SECOND FLOOR (Additional floor areas to be inserted) ■ YES □ NO (EXPLAIN): 16 BARRIER-FREE DESIGN 9.5.2 9.10.1.3.(4) ☐ YES ■ NO HAZARDOUS SUBSTANCES 18 REQUIRED FIRE RESISTANCE RATING (FRR) HORIZONTAL LISTED DESIGN NO. OR ASSEMBLIES FRR (HRS DESCRIPTION (SB) FLOORS 2 HOURS ROOF 0 HOURS 3.2.2.20.-.83 & 9.10.8 & MEZZANINE N/A HOURS LISTED DESIGN NO. OR FRR OF SUPPORTING DESCRIPTION (SB) FLOORS 2 HOURS ROOF 0 HOURS
MEZZANINE N/AHOURS 19 SPATIAL SEPARATION - CONSTRUCTION OF EXTERIOR WALLS 3.2.3.1.D 9.10.14 Comb Comb. Constr. Max % of Design or Const | None. Cladding | Description Openings Openings No Restrictions South McCraney Street 1,633 14.6 | 100 % No Restrictions 2,450 16.9 | 100 % No Restrictions

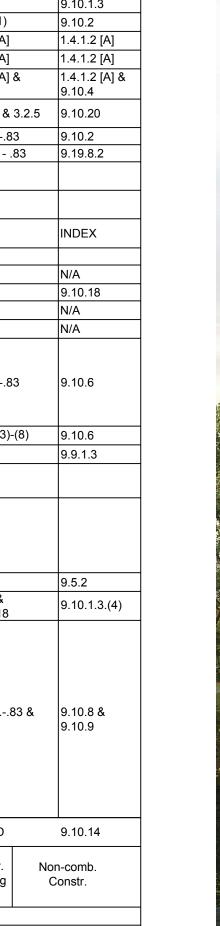



No Restrictions

OBC Matrix

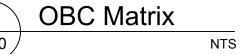


15.2 | 100 %

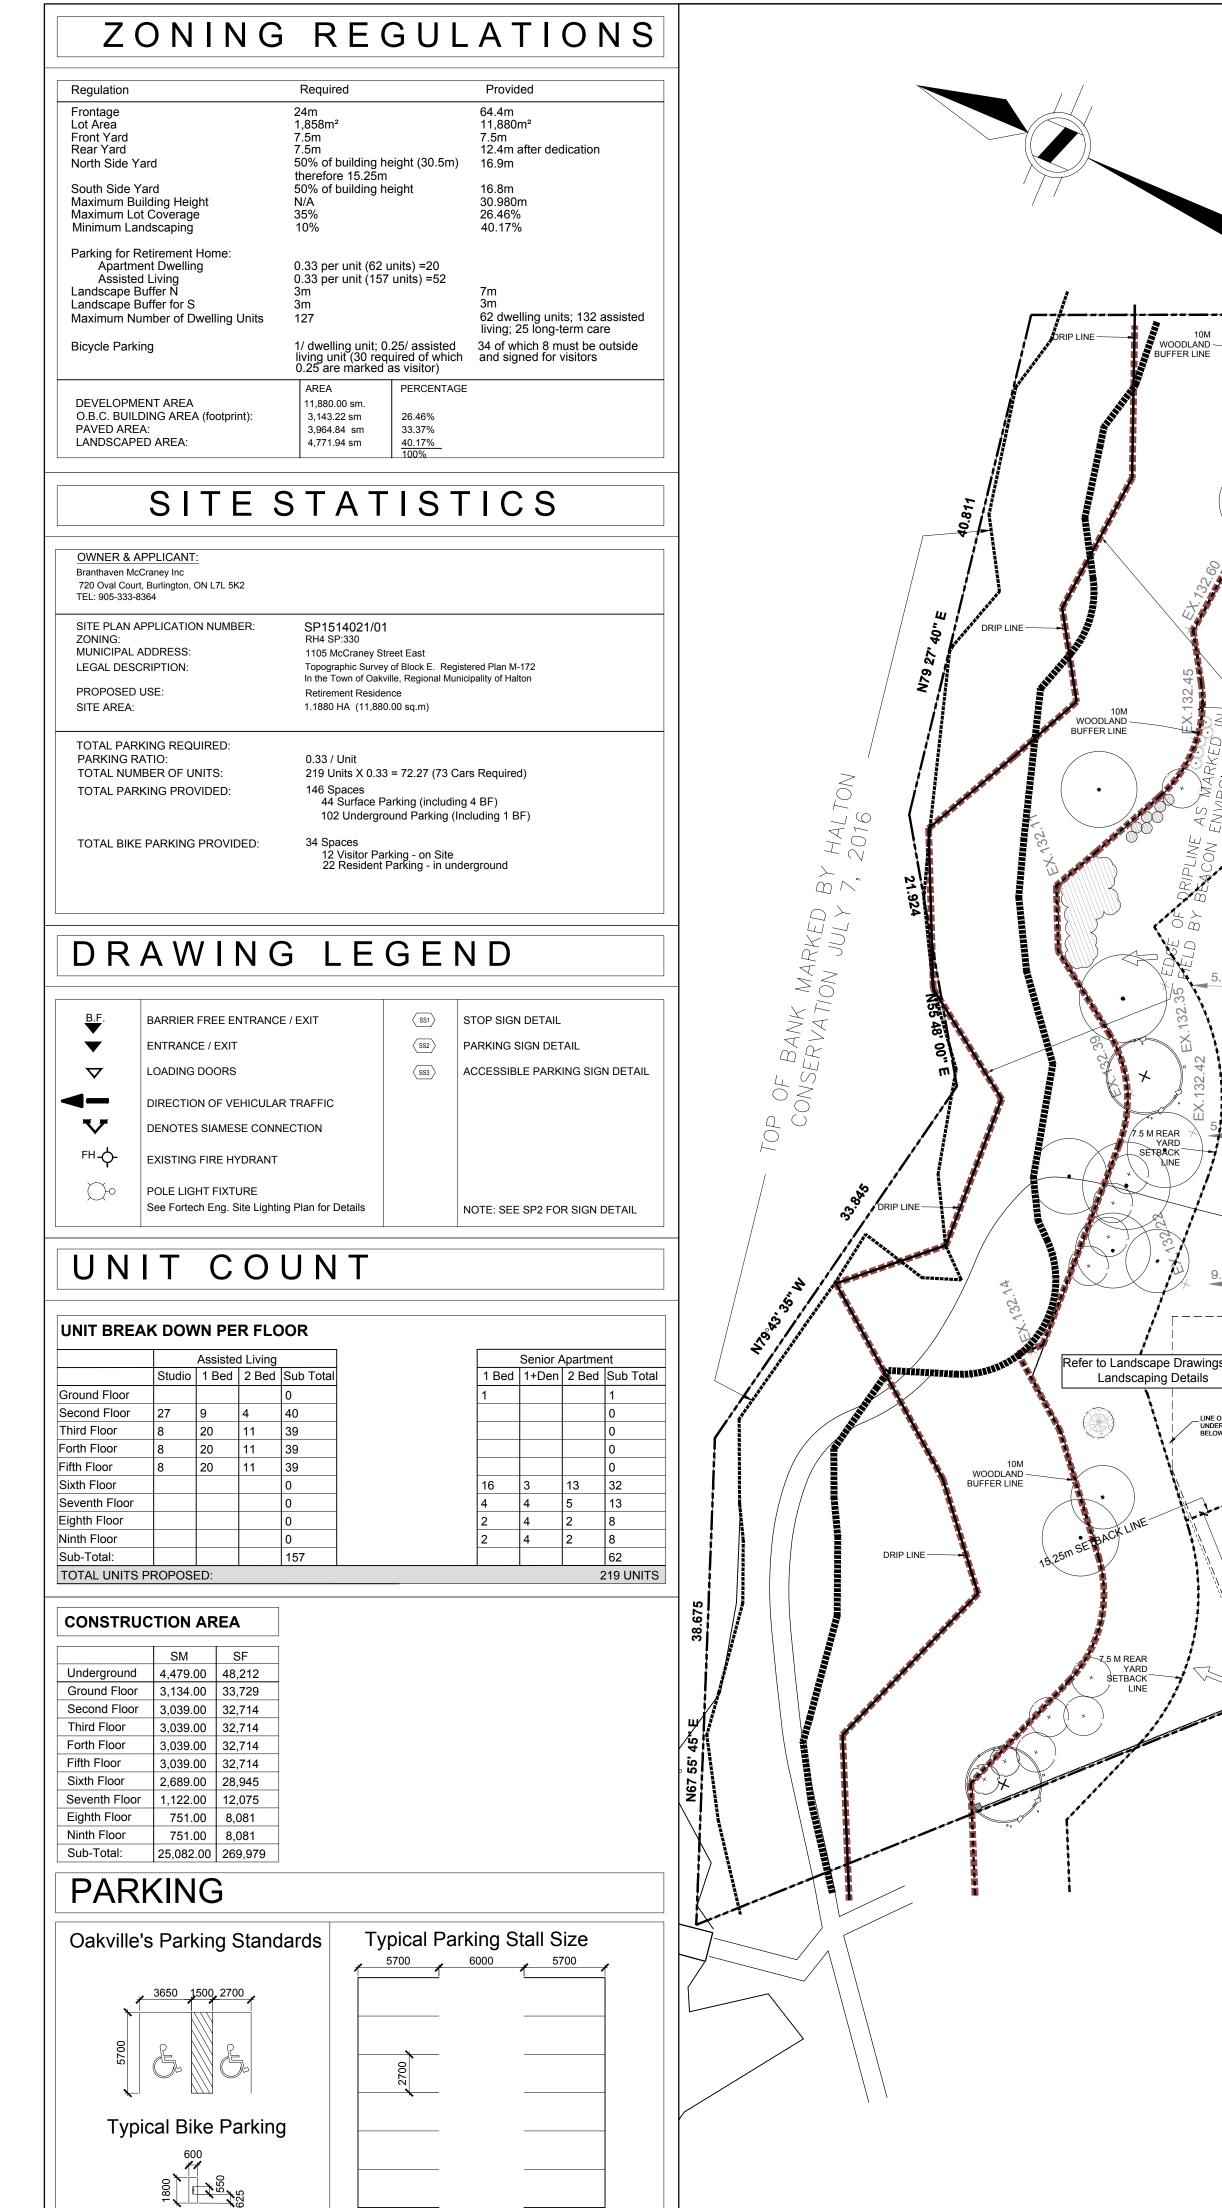

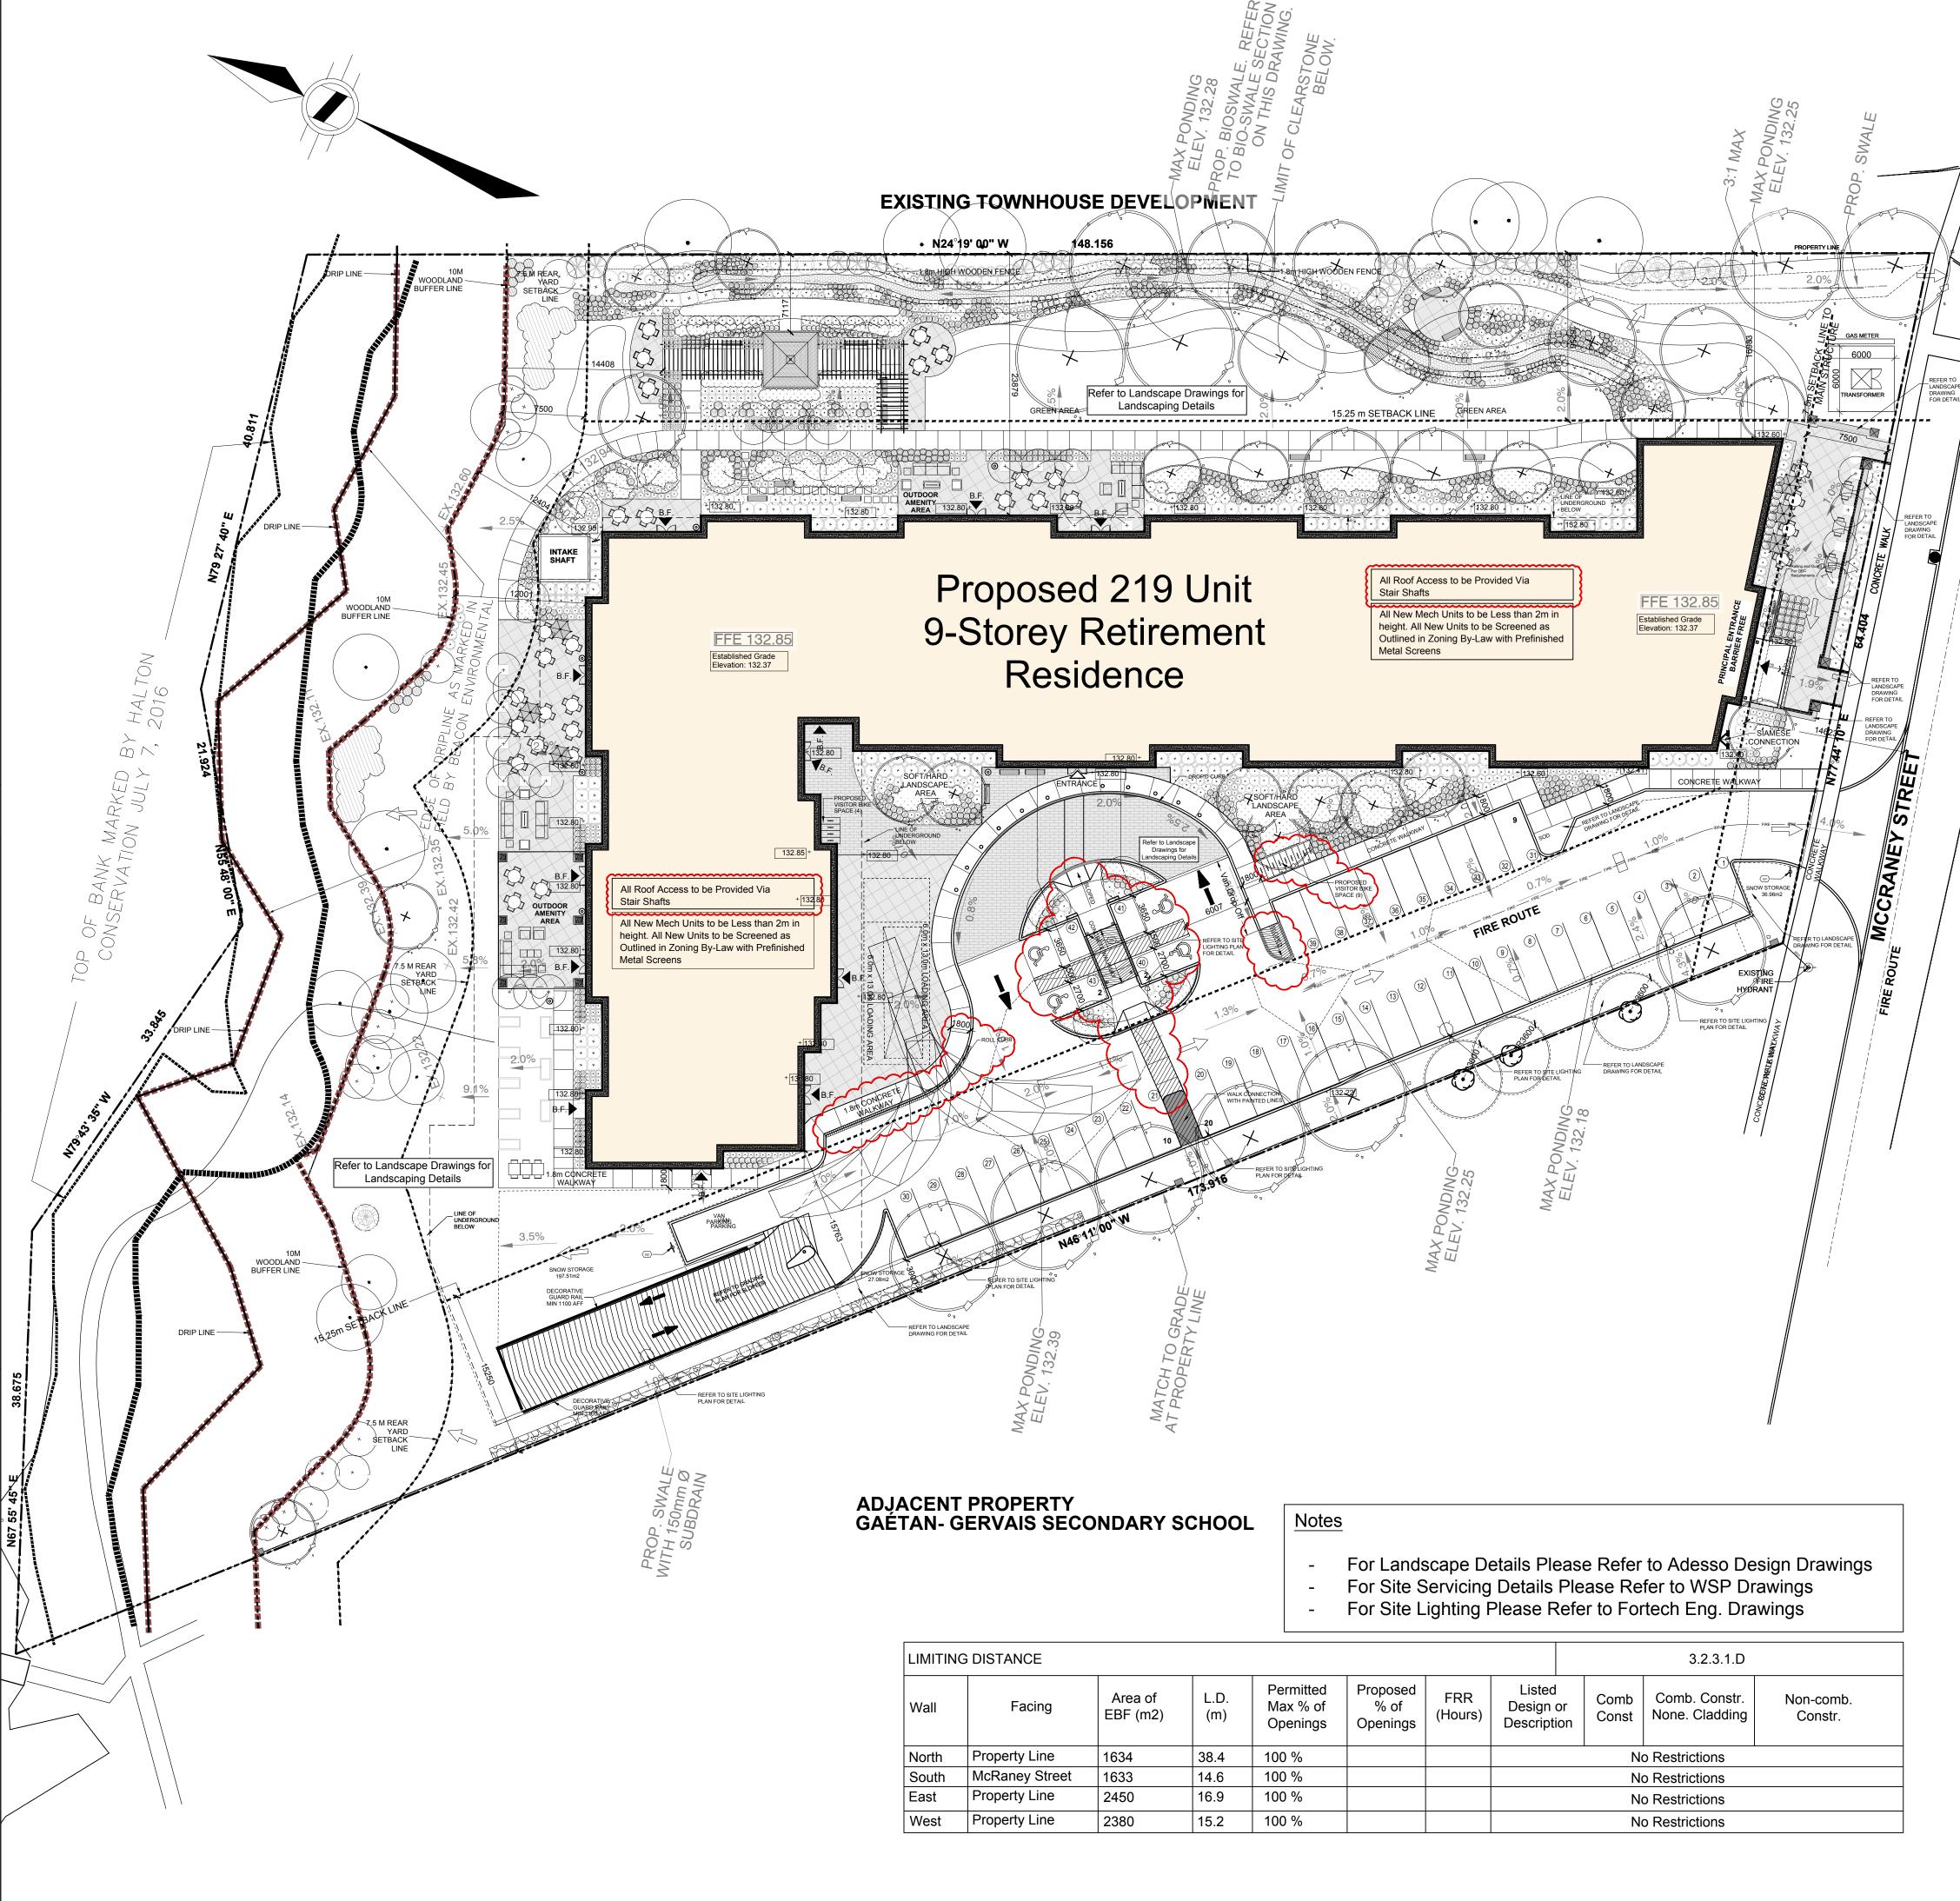



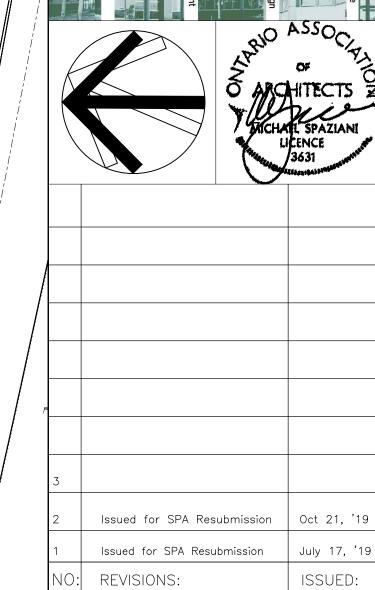

NOTE: This drawing is the property of the Architect and may not be reproduced or used without the expressed consent of the Architect. The contractor is to verify all dimensions and conditions on the project and to report any discrepancies to the Architect prior to commencing work. These drawings are not to be used for construction purposes unless indicated as "issued for construction".

CLIENT:

Branthaven McCraney Inc.

Oakville, Ontario

PROJECT:


McCraney Retirement Residence

1105 McCraney Street East Oakville, Ont. SP1514021/01


SHEET TITLE:


Site Plan


PROJECT NO.	
C8046	
SCALE:	DATE:
1:300	July 2019
DRAWN:	SHEET NO:
CHECKED:	
msai	SPI
FILE NO.	
C8046	

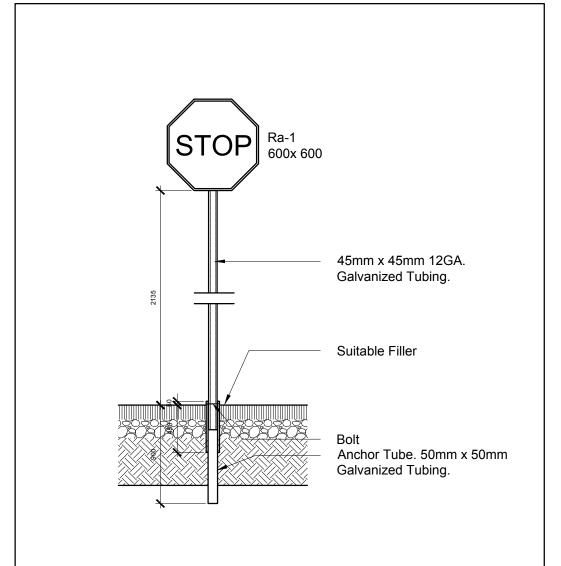


Stop Sign Detail

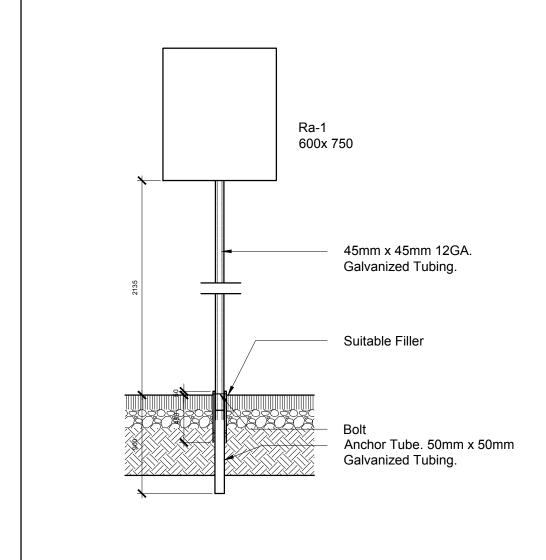

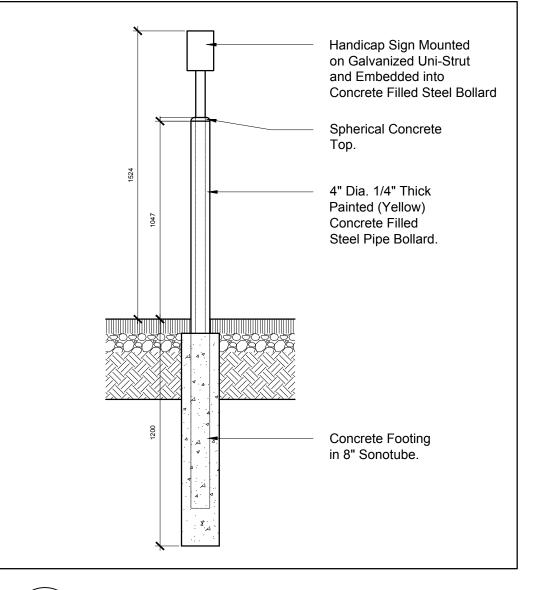

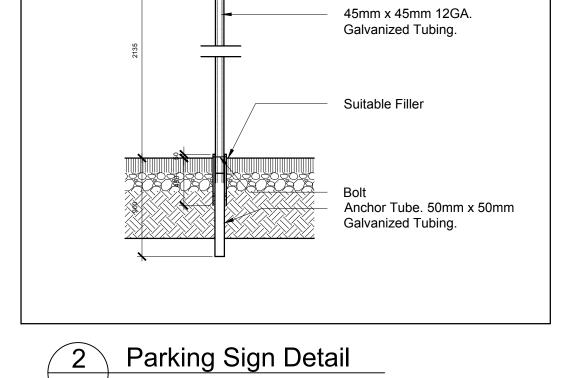





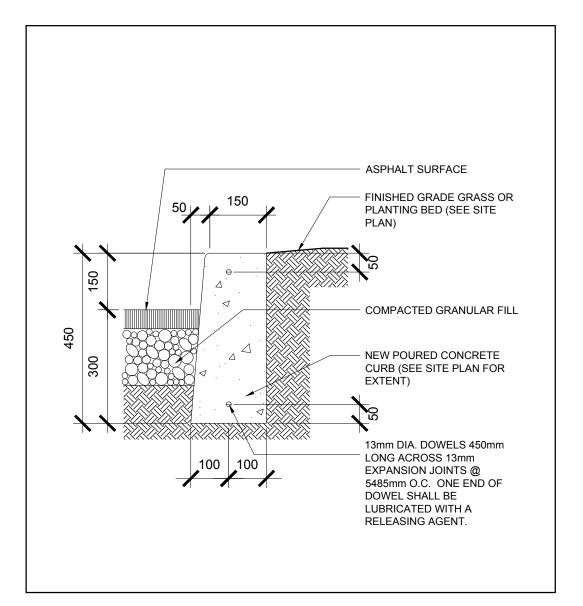


Concrete Curb @ Landscape


4 SP2

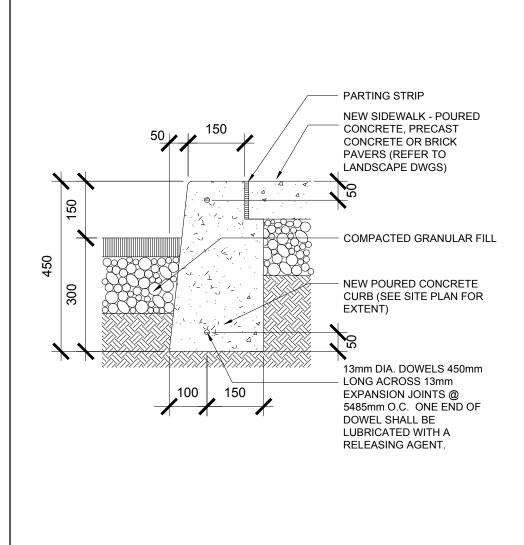


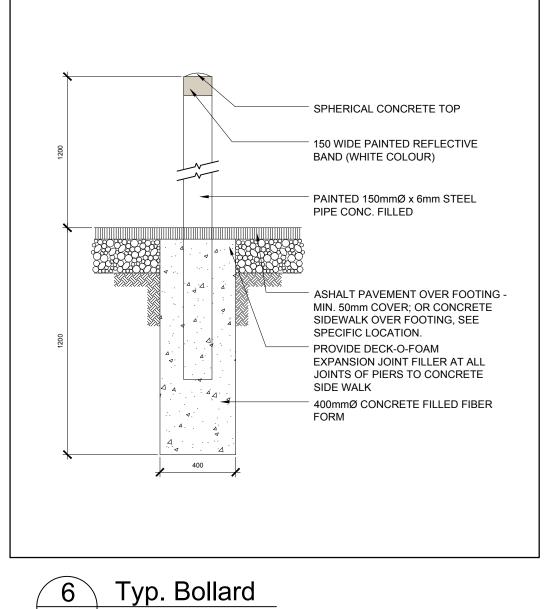




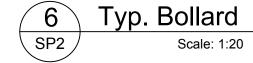

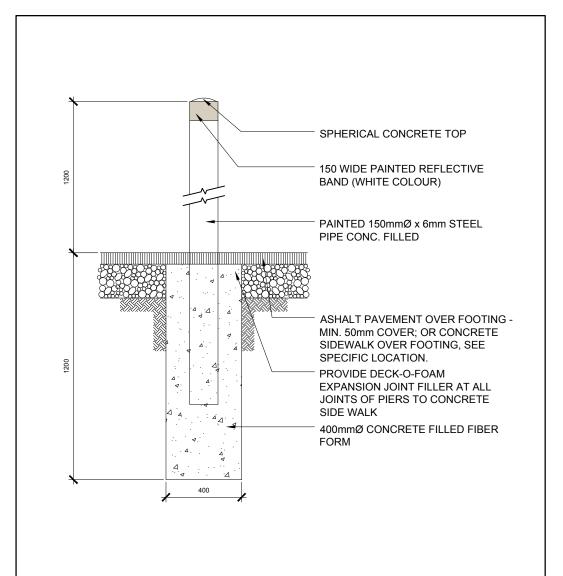

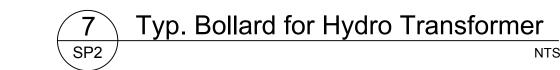

OF THE VAULT.

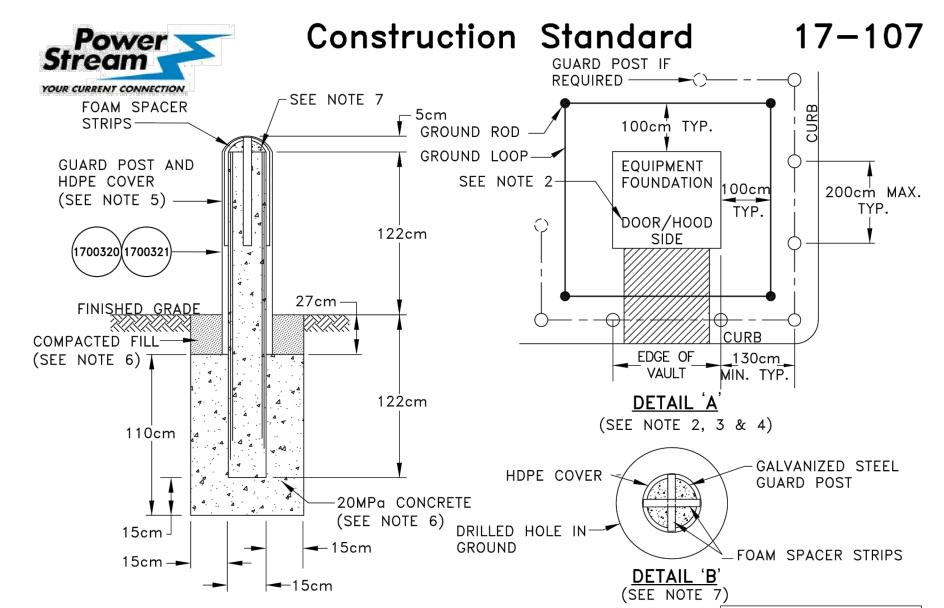

NOTES:												
CUSTOMER IS	TO SI	JPPLY /	AND I	NSTALL	GUARD	POSTS	(BOLLARD	S) IF	THE	EQUIPMENT	IS	LESS
THAN 300cm	(120") FROM	THE	TRAVEL	ED ARE	A OR	ANYWHERE	POWE	RSTR	EAM DEEMS		
NECESSARY.												

2.	NUMBER OF GUARD POSTS AND LOCATIONS AE EXAMPLES ONLY. ACTUAL LOCATIONS AND
	NUMBERS TO BE DETERMINED BY POWERSTREAM ENGINEERING TECHNICIAN AND MODIFICATIONS
	CAN BE MADE BY POWERSTREAM INSPECTORS IN THE FIELD WITH THE APPROVAL OF THE ENG
	TECHNICIAN AND WITH THE FOLLOWING CRITERIA:

FULL RANGE. GUARD POSTS AT THE EDGES OF THE SHADED AREA MUST BE INSTALLED AT THE EDGE OF THE VAULT. B) GUARD POST INSTALLATIONS SHALL ALLOW POWERSTREAM PERSONNEL UNIMPEDED

A) GUARD POST INSTALLATIONS SHALL ALLOW EQUIPMENT DOORS TO BE OPENED THEIR

- ACCESS TO THE EQUIPMENT. 3. THE GUARD POSTS SHALL BE INSTALLED A MINIMUM OF 130cm (12") FROM THE EDGE
- 4. INSTALL GUARD POSTS AT THE CORNERS FIRST, THEN INSTALL THE INTERMEDIATE GUARD POSTS. THE DISTANCE BETWEEN TWO GUARD POSTS SHALL BE MAXIMUM OF 200cm (79").
- 5. POWERSTREAM APPROVED GUARD POST SHALL BE 15cm (6") DIAMETER x 244cm (96") LONG 0.76cm $(\frac{1}{3}")$ THICK WELDED SEAM GALVANIZED STEEL PIPE(MINIMUM GAUGE SCHEDULE 40) COVERED WITH A 18cm (7") DIAMETER x 152cm (60") LONG SEAMLESS HIGH DENSITY POLYETHYLENE (HDPE) RESIN PIPE COVER.
- 6. DIG 45cm (14") DIAMETER x 137cm (54") DEEP HOLE IN GROUND AND POUR 110cm (42") OF 20Mpa (2900 PSI) CONCRETE AROUND THE GUARD POST KEEPING 15cm (6") BELOW THE GUARD POST AS A BASE. FILL THE REMAINING 27cm (11") AROUND THE GUARD POST WITH FILL COMPACTED TO 95% STANDARD PROCTOR DENSITY.
- 7. STEEL GUARD POSTS SHALL BE FILLED WITH 20Mpa (2900 PSI) CONCRETE WITH THE TOP ROUNDED. TWO FOAM SPACER STRIPS ARE REQUIRED TO BE PLACED ACROSS THE TOP BETWEEN THE STEEL GUARD POST AND THE HDPE COVER.
- 8. BOLLARDS, GROUNDING GRIDS, AND VAULTS MUST BE INSPECTED BY POWERSTREAM INSPECTIONS DEPARTMENT PRIOR TO THE ENERGIZATION TO THE TRANSFORMER POWERSTREAM INSPECTION DEPARTMENT MUST BE CONTACTED 48HOURS PRIOR TO AN INSPECTION.

9. ALL DIMENSIONS ARE IN CENTIMETERS.

GUARD POSTS (BOLLARDS) INSTALLATION OUTSIDE OF GROUNDING GRID 30 OR 10 TX.

EQUIPMENT PROTECTION (NON RESIDENTIAL) P.Eng. Approval By: ___Joe Crozier ORIGINAL ISSUE DATE: 2010-NOV-30 REVISION NO: R2 REVISION DATE: 2012-FEB-06

NOTE: This drawing is the property of the Architect and may not be reproduced or used without the expressed consent of the Architect. The contractor Certificate of Approval This construction Standard meets the safety is to verify all dimensions and conditions on the project and to report any discrepancies to the Architect prior to commencing work. These drawings are not to be used for construction purposes unless indicated as "issued for construction". requirements of Section 4 of Regulation 22/04 Joe Crozier, P.Eng. 2011-FEB-06

CONVERSION TABLE

15cm

27cm

30cm 50cm

100cm

122cm

130cm

200cm

IMPERIAL (APPROX.)

0'-11"

1'-0"

1'-8"

3'-3"

4'-0"

4'-3"

6-7"

CLIENT:

Branthaven McCraney Inc.

Issued for SPA Resubmission

Issued for SPA Resubmission

6 Helene Street N, Suite 100

T 905 891 0691 F 905 891 0514

Port Credit, Mississauga ON L5G 3B2

Oakville, Ontario

PROJECT:

McCraney Retirement Residence

1105 McCraney Street East Oakville, Ont. SP1514021/01

SHEET TITLE:

Miscellaneous Details

PROJECT NO.	
C8046	
SCALE:	DATE:
As Noted	July 2019
DRAWN:	SHEET NO:
CHECKED:	CDO
msai	SP2
FILE NO.	
C8046	

